DEVELOPMENT APPLICATION



DRAWING LIST

drawing number

ar--3300

ar--4200

| arcv00 | Cover page and drawing list | N/A |
|--------|-----------------------------|-------|
| ar0100 | Site Plan | 1:200 |
| ar0300 | Demolition Plan | 1:100 |
| ar1200 | Basement Plan | 1:100 |
| ar1201 | Ground Level Plan | 1:100 |
| ar1202 | Level 1 Plan | 1:100 |
| ar1203 | Level 2 Plan | 1:100 |
| ar1204 | Level 3 Plan | 1:100 |
| ar1205 | Roof Plan | 1:100 |
| ar2200 | Section 1 & 2 | 1:100 |
| ar2201 | Section 3 & 4 | 1:100 |
| ar2202 | Section 5 & 6 | 1:100 |
| ar2600 | West and East Elevations | 1:100 |
| ar2601 | North and South Elevations | 1:100 |

Adaptable Unit Layout

Wall Detail Sections

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description

scale

1:50

UNITS SCHEDULE

| | | | | | Solar | | | | | | | | Solar | | |
|----------|-----------|------------------|------------------|-------------------|-----------|-------------|----------------------|---------|-----------|------------------|------------------|------------------|-----------|-------------|----------------------|
| | | Internal | POS/ | | Access | Cross | | | | Internal | POS/ | | Access | Cross | |
| Unit No | Unit Type | Area | Balcony | Total Area | (Min 2hr) | ventilation | LHDG/AS4299 | Unit No | Unit Type | Area | Balcony | Total Area | (Min 2hr) | ventilation | LHDG/AS4299 |
| Ground f | | | | | | | | Level 2 | | | | | | | |
| (G01 | 2 Bed | 70m ² | 34m ² | 104m ² | Yes | Yes | Livable - Gold level | 201 | 2 Bed | 70m ² | 10m ² | 80m ² | Yes | Yes | Livable - Gold level |
| G02 | 1 Bed | 53m² | 27m ² | 80m² | Yes | Yes | Livable - Gold level | 202 | 1 Bed | 53m ² | 10m ² | 63m² | Yes | Yes | Livable - Gold level |
| G03 | 1 Bed | 58m ² | 23m ² | 81m² | Yes | No | Adaptable AS4299 | 203 | 1 Bed | 52m ² | $9m^2$ | 61m² | Yes | No | Livable - Gold level |
| G04 | 1 Bed | 53m ² | 27m ² | 80m² | Yes | No | Livable - Gold level | 204 | 1 Bed | 53m ² | $9m^2$ | 62m² | Yes | No | Livable - Gold level |
| G05 | 2 Bed | 70m ² | 36m ² | 106m² | Yes | Yes | Livable - Gold level | 205 | 2 Bed | 70m ² | 11m ² | 81m² | Yes | Yes | Livable - Gold level |
| G06 | 2 Bed | 76m ² | 11m ² | 87m² | No | Yes | Livable - Gold level | 206 | 2 Bed | 80m ² | 11m ² | 91m² | No | Yes | Adaptable AS4299 |
| Level 1 | | | | | | | | Level 3 | | | | | | | |
| 101 | 2 Bed | 70m ² | 10m ² | 80m² | Yes | Yes | Livable - Gold level | 301 | 1 Bed | 55m ² | 15m ² | 70m ² | Yes | Yes | Livable - Gold level |
| 102 | 1 Bed | 53m ² | 10m ² | 63m ² | Yes | Yes | Livable - Gold level | 302 | 1 Bed | 52m ² | 9m ² | 61m ² | Yes | No | Livable - Gold level |
| 103 | 1 Bed | 52m ² | 9m ² | 61m ² | Yes | No | Livable - Gold level | 303 | 1 Bed | 53m ² | $9m^2$ | 62m² | Yes | No | Livable - Gold level |
| 104 | 1 Bed | 53m ² | 9m ² | 62m ² | Yes | No | Livable - Gold level | 304 | 2 Bed | 73m ² | 11m ² | 84m² | Yes | Yes | Livable - Gold level |
| 105 | 2 Bed | 70m ² | 11m ² | 81m² | Yes | Yes | Livable - Gold level | | | | | | | | |
| | | 2 | 2 | 2 | | | | | | | | | | | |

Adaptable AS4299

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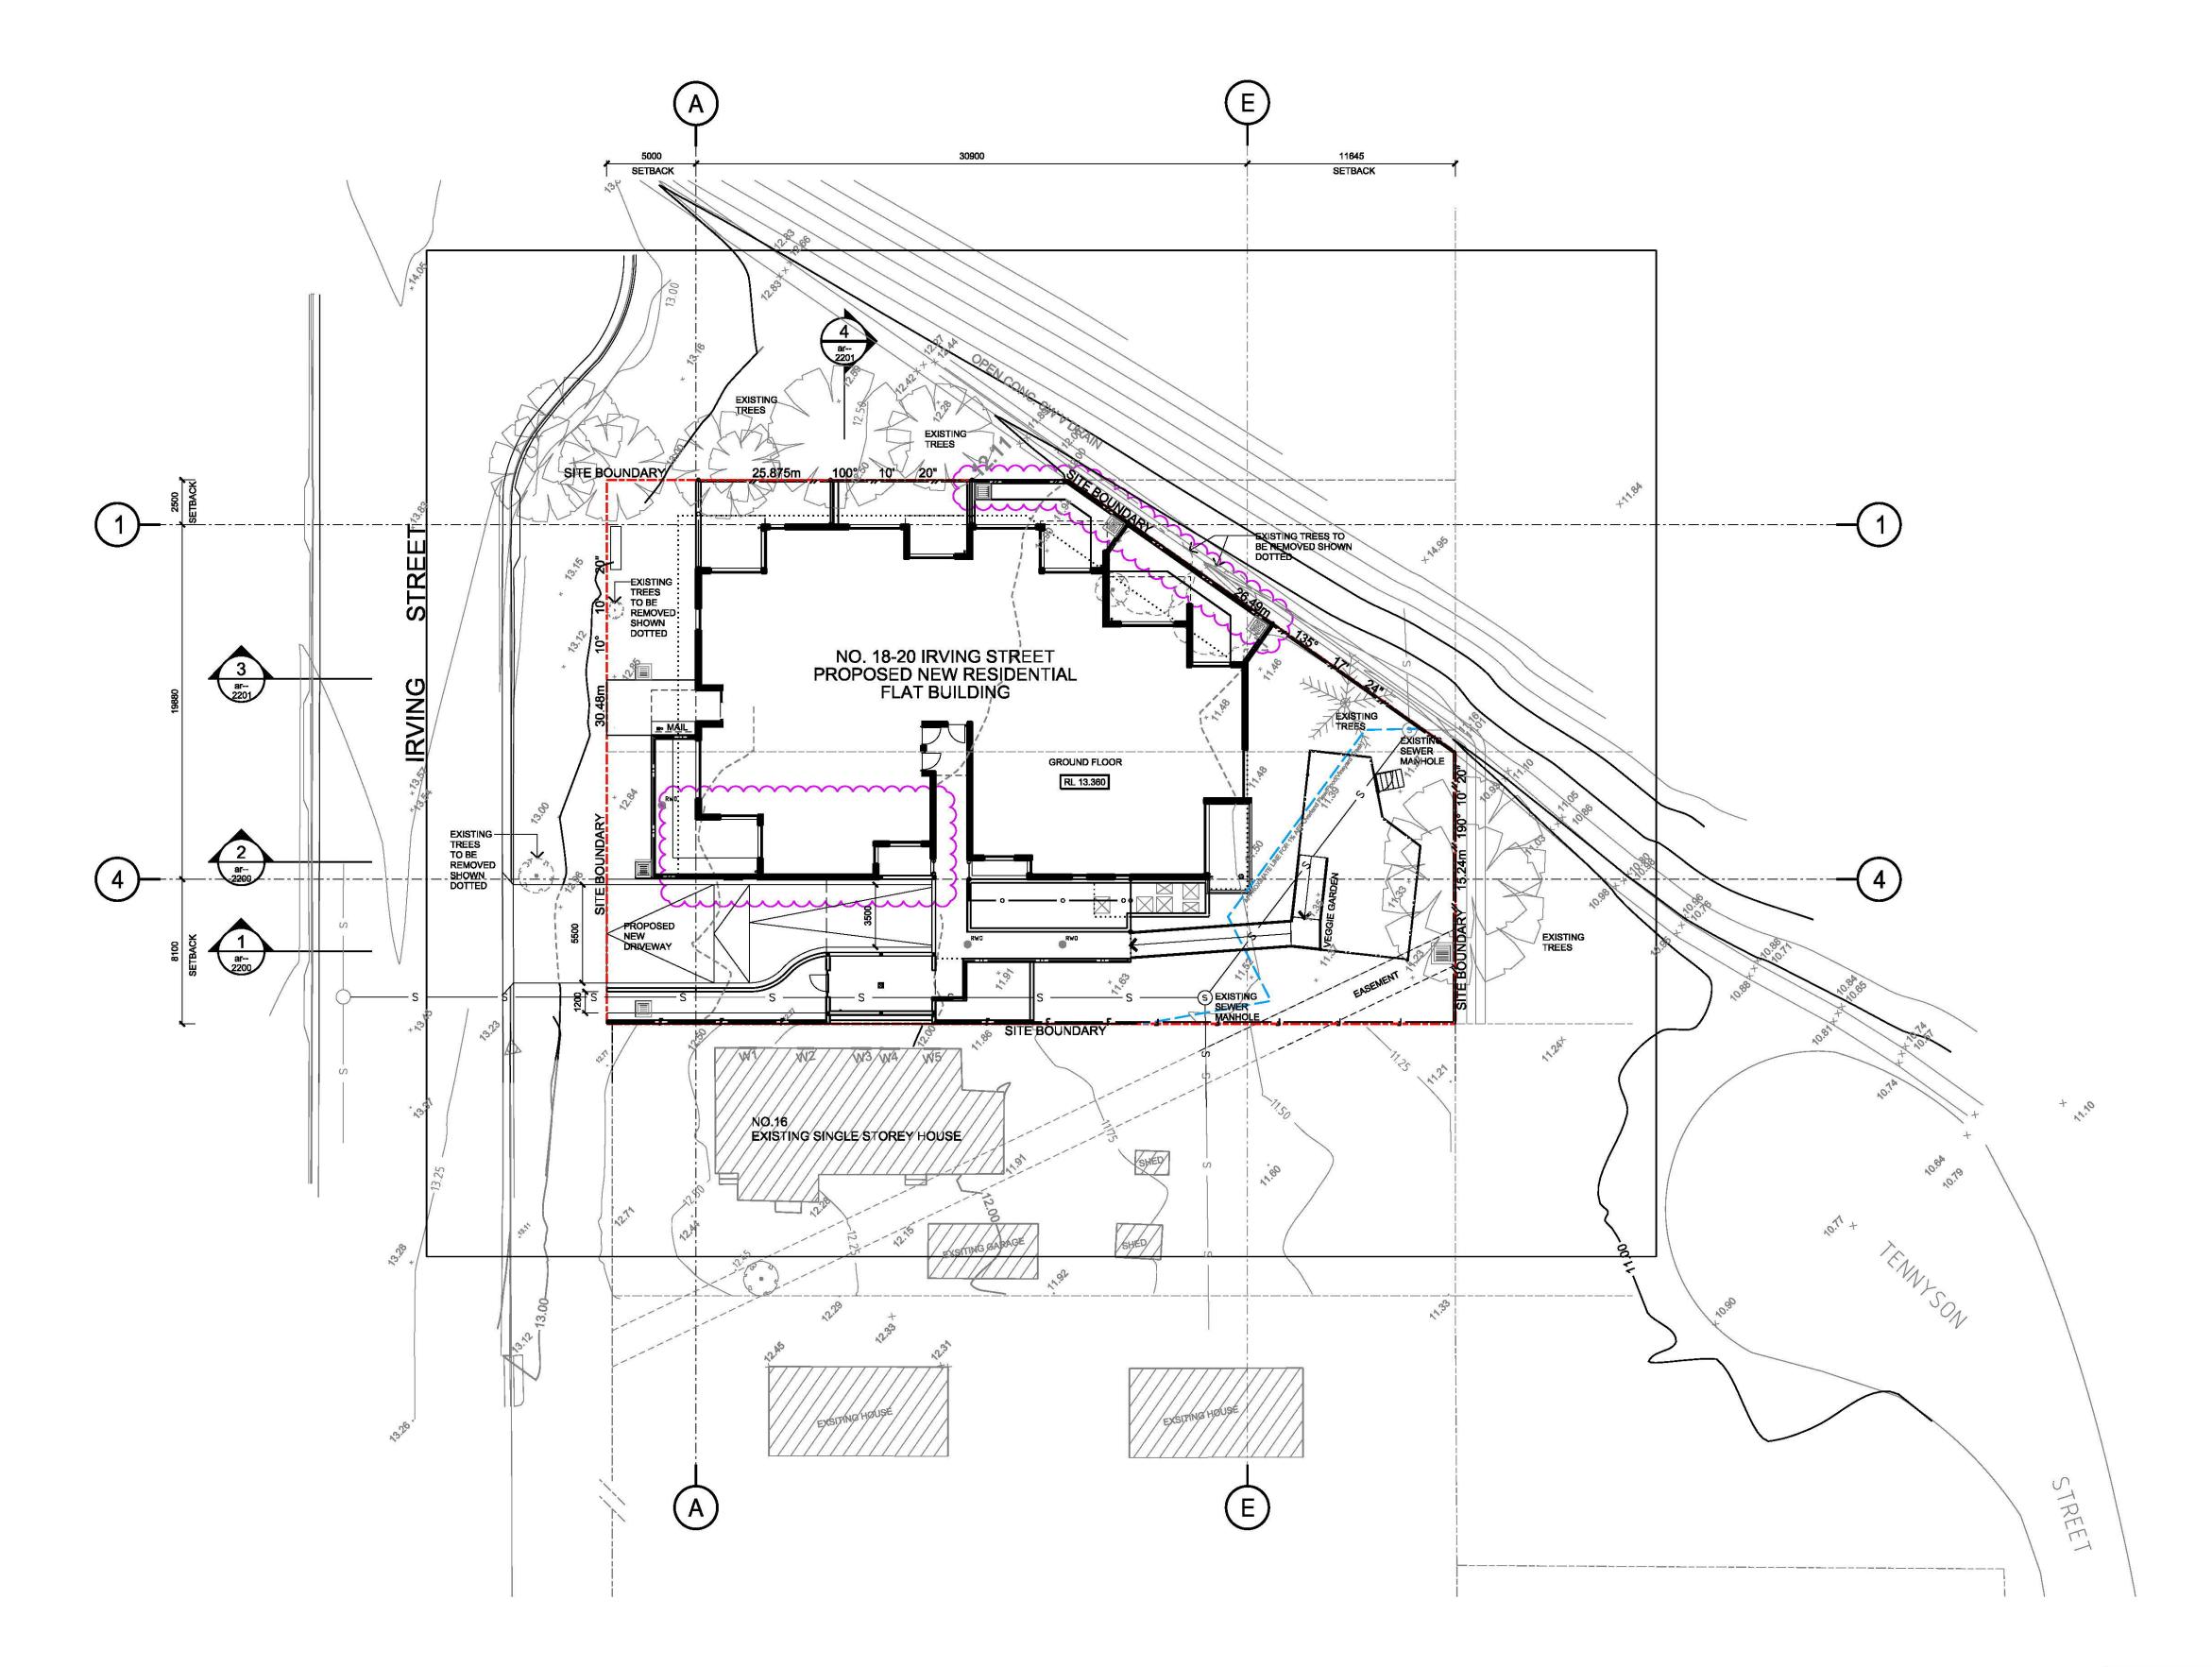


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cover page & drawing list

| original | scale | drawn | project no. |
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| a1 | nts | wj | 4477-00 |
| drawing no | · | , see a g | rev no. |



Planning requirements : Zone R4 High Density Residential Site Area: 1280.30 m²

| | SEPP ARH 2009 | LEP | Proposed |
|----------------------|---------------------|---------------------|---------------------------|
| FSR | 1.3:1 | 0.8:1 | 1.25:1 |
| GFA | 1664 m ² | 1024 m ² | 1598 m ² |
| Height Limit | | Max.: 11.0 m | Front: 14.1m, Rear: 15.1m |
| | | | 3.5 storeys |
| Resident Car Parking | 11 spaces | - | 11 spaces |
| Bicycle Parking | - | 11 spaces | 11 spaces |

| | SEPP ARH 2009 | ADG (SEPP 65) | Proposed |
|-----------------|--|-----------------------|---------------------------|
| Deep soil Zone | Min. 15% | Min. 7% | 21.8% |
| Deep son zone | 192.05 m ² | 89.62 m ² | 280 m ² |
| Lands cape Area | 35 m ² x 22 units 770 m2 | - | 28% 362 m ² |
| Communal Open | | Min. 25% | 26.1% |
| Space | - | 320.08 m ² | 334 m ² |

| | SEPP ARH 2009 | ADG (SEPP 65) | Proposed |
|---------------------|-----------------|-----------------|------------------------------|
| Solar Access | Min. 70% - 3hrs | Min. 70% - 2hrs | 86.4% - 2hrs 72.7% - 3hrs |
| Cross Ventilation | - | Min. 60% | 63.6% |
| No Direct Sun light | - | Max. 15% | 0% |

NOTES:
-REFER TO SURVEY DRAWING BY OPUS
INTERNATIONAL CONSULTANTS
(AUSTRALIA) PTY LTD
-REFER TO LANDSCAPE DRAWING FOR
EXTERNAL WORKS AND LEVELS

| | 1 bed | 2 bed | Total |
|--------------|-------|-------|-------|
| Ground floor | 3 | 3 | 6 |
| Level 1 | 3 | 3 | 6 |
| Level 2 | 3 | 3 | 6 |
| Level 3 | 3 | 1 | 4 |
| Total | 12 | 10 | 22 |
| % | 55% | 45% | 100% |

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a02


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site plan

ar--0100

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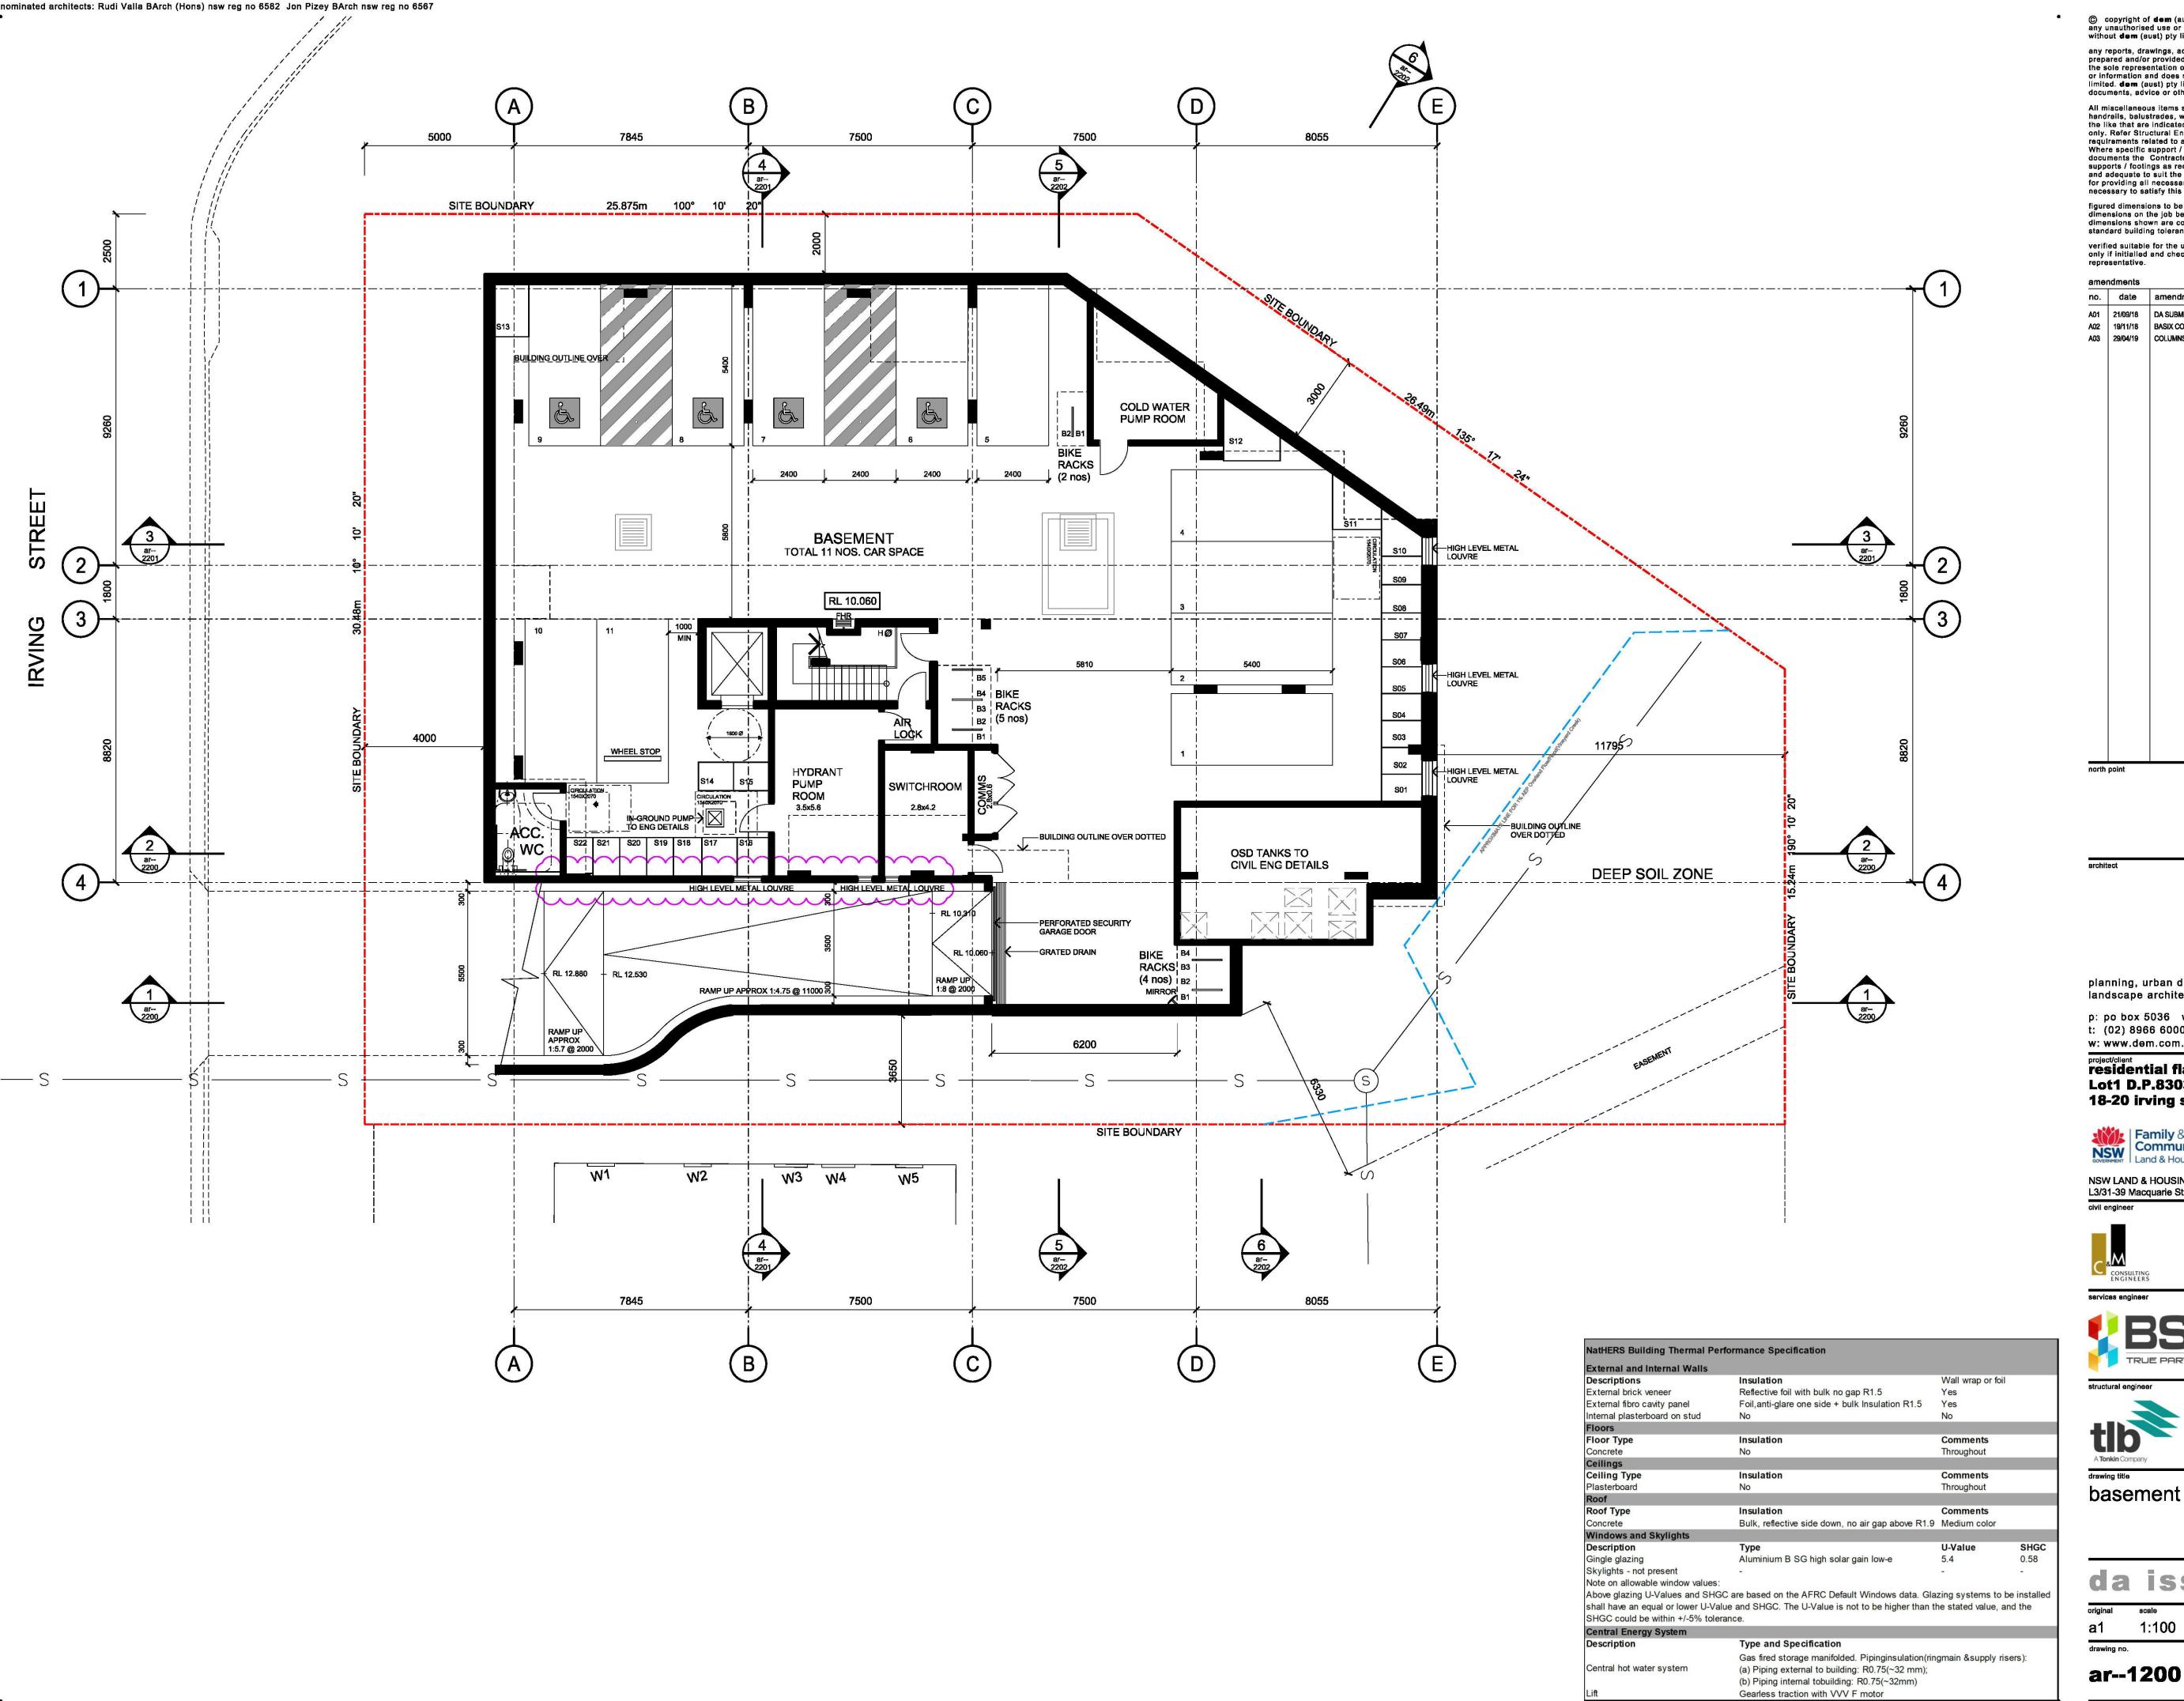
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NOTES:
- DEMOLOTION WORK SHOW IN DOTTED
- EXISTING SERVICES TO BE RELOCATED/
RECONNECTED TO ENGINEER'S DETAILS

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ar--0300 a01

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plotted by: WJin
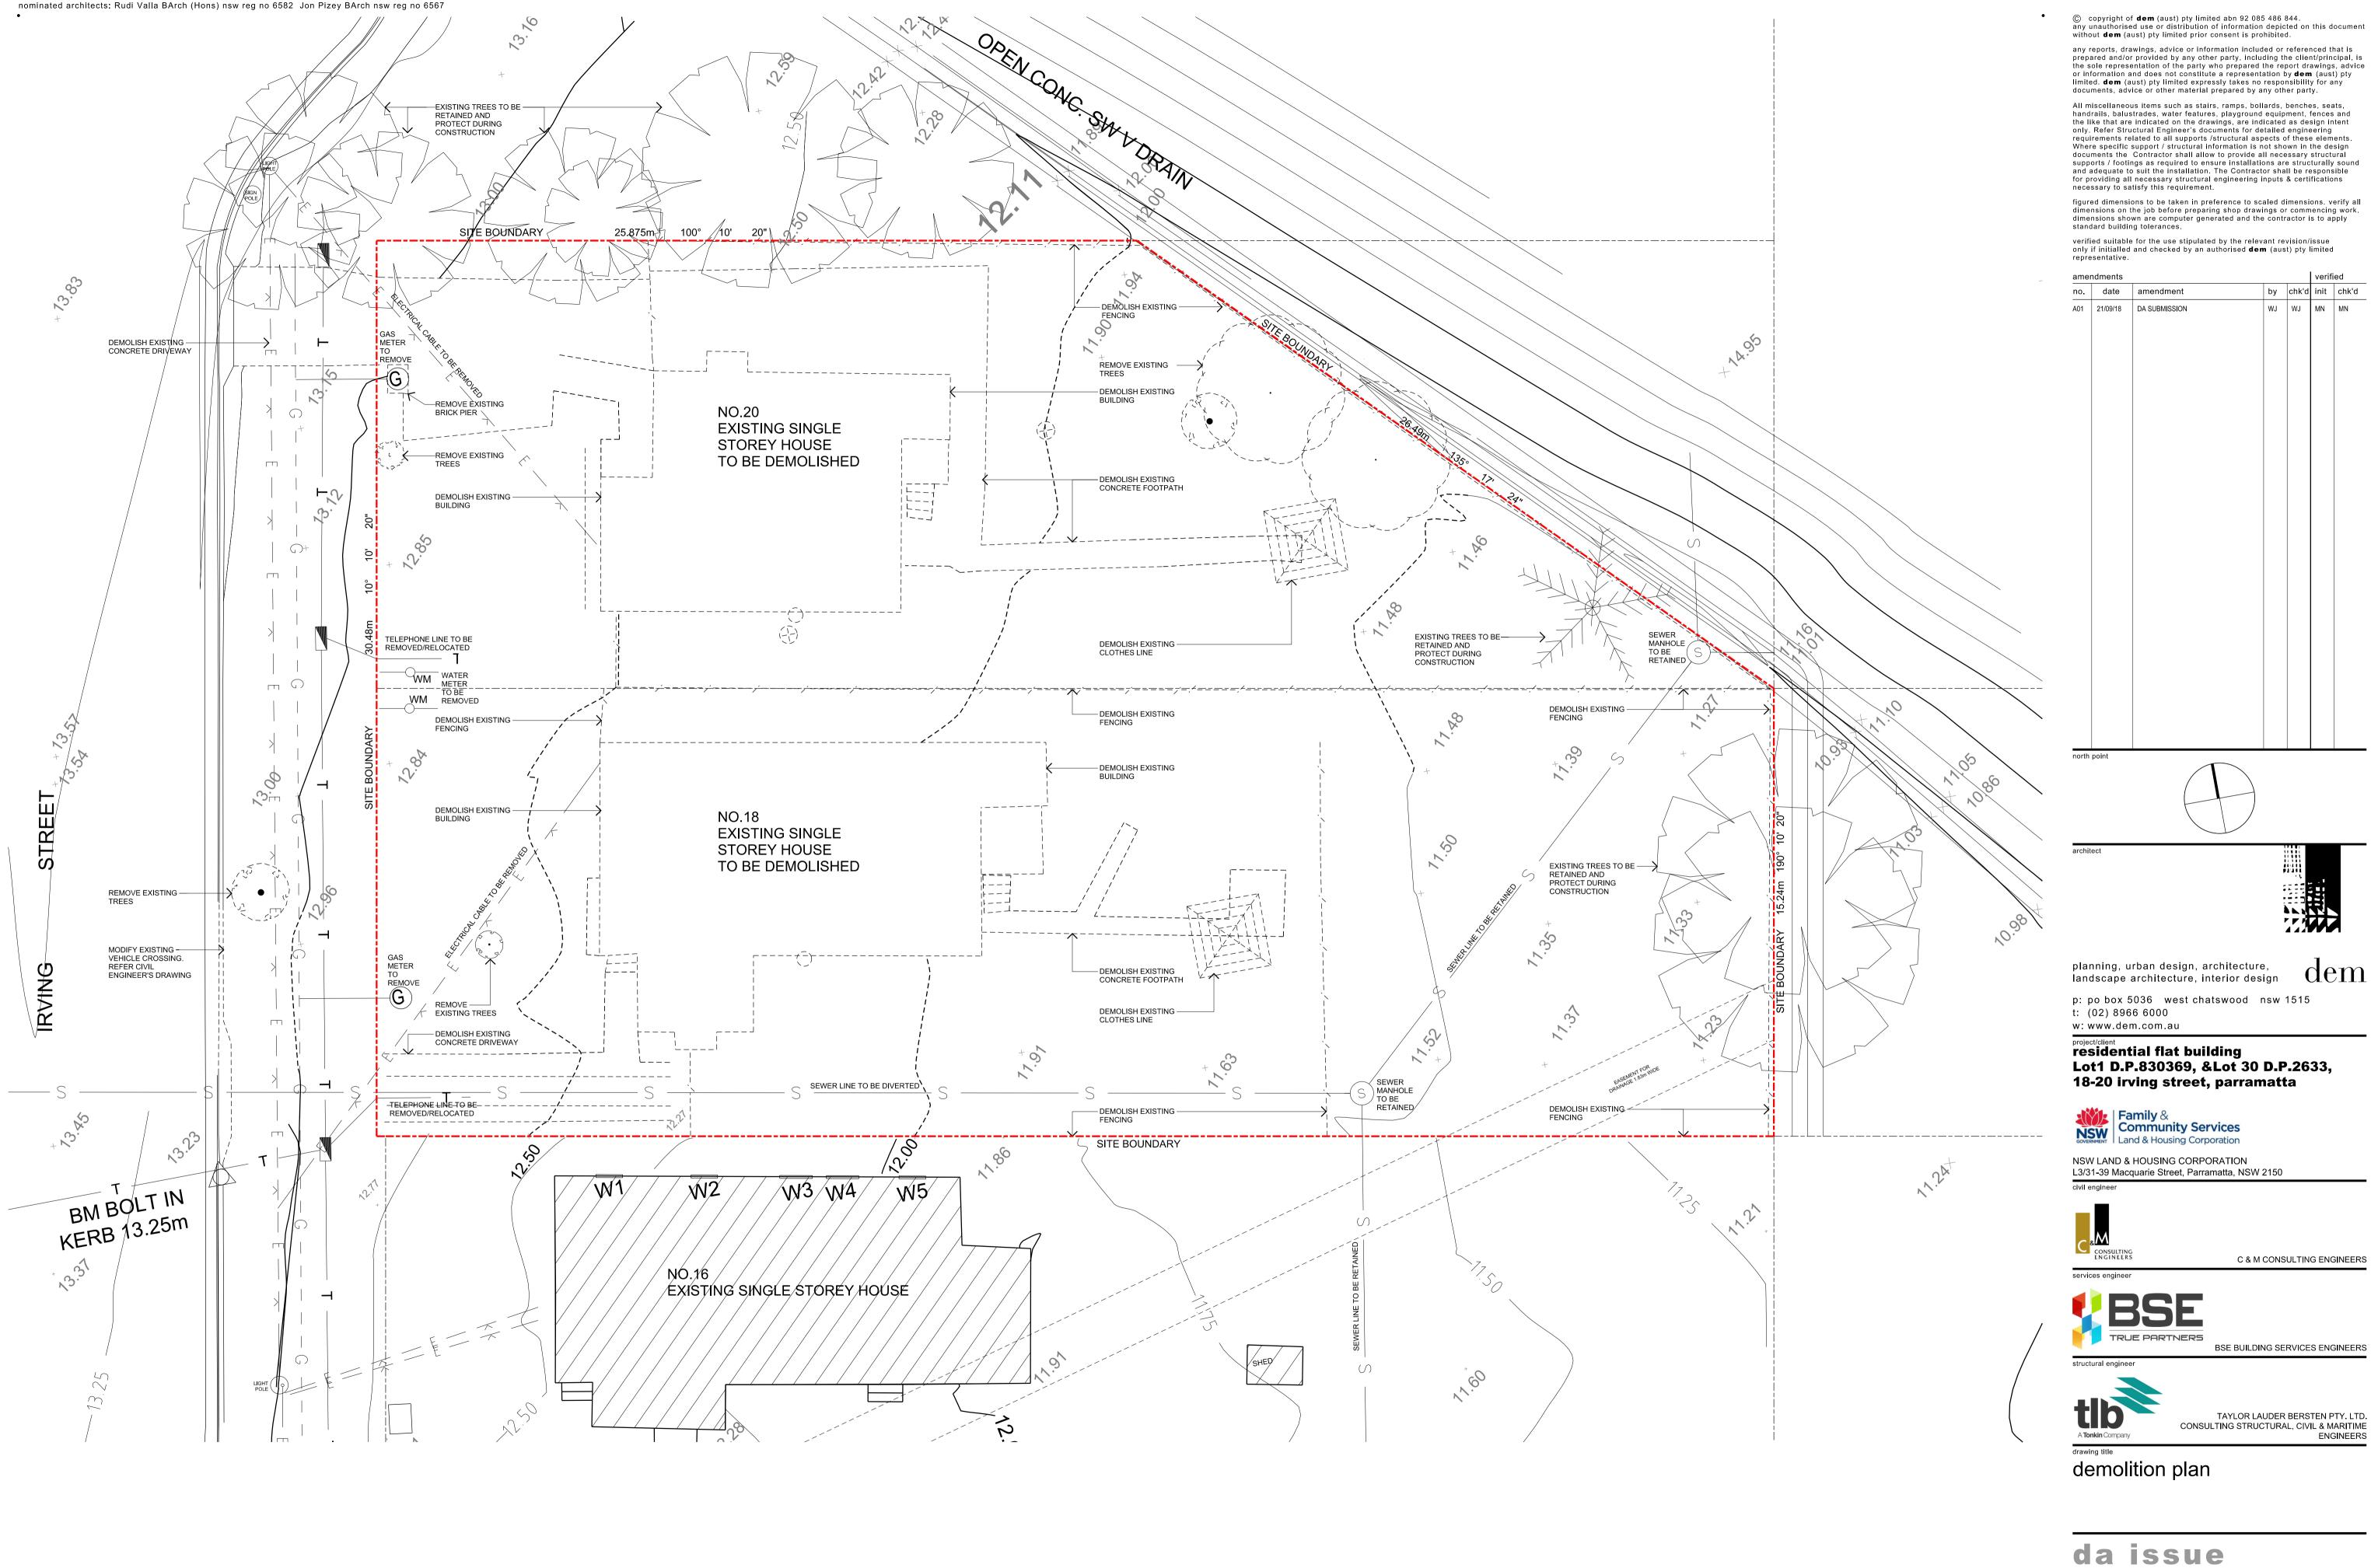
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| A02 | 19/11/18 | BASIX COMMITMENTS ADDED | MN | MN | MN | MN |
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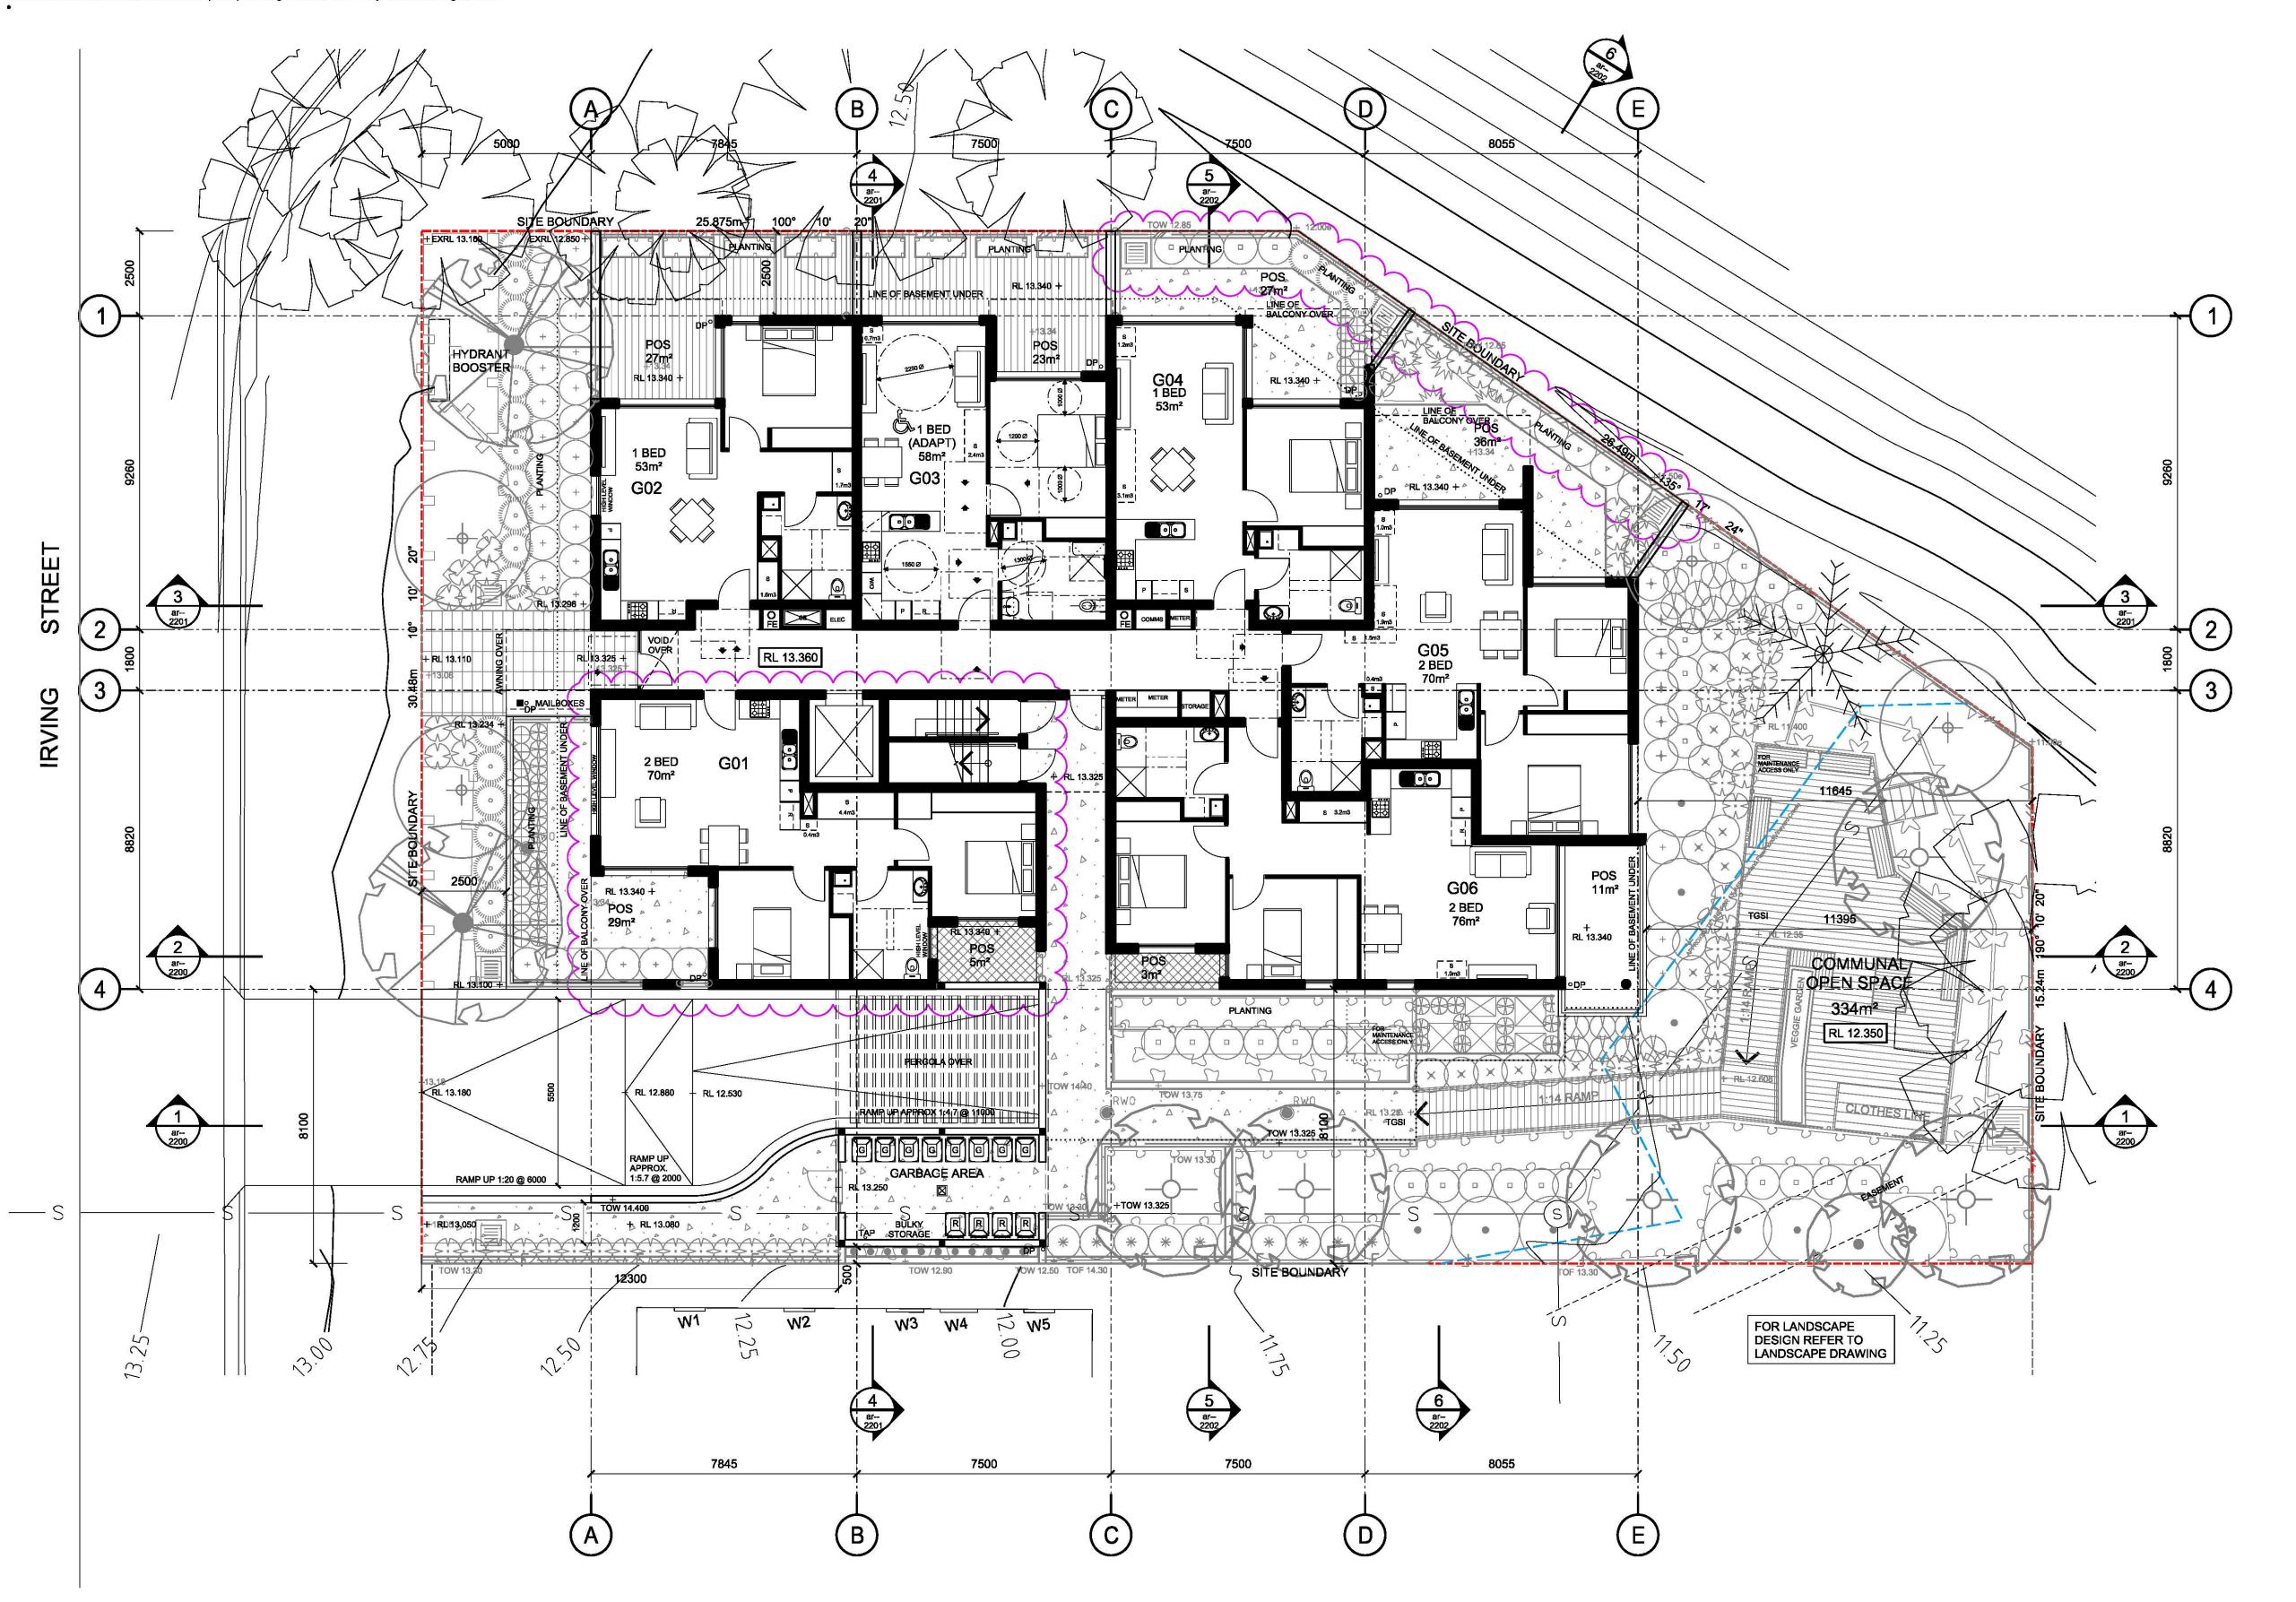
ENGINEERS

a03

drawing title

basement plan

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a03

ground floor plan

ar--1201

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| AQ3 14/05/19 UNIT 101 UPDATED WJ WJ ET ET | A02 29/04/19 | UNIT 101 UPDATED | WJ | WJ | ET | ET |
| | A03 14/05/19 | UNIT 101 UPDATED | WJ | WJ | ET | ET |
| | north point | | | | | |

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a03

drawing title

level 1 plan

ar--1202

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| original | scale | drawn | project no. |

nominated architects: Rudi Valla BArch (Hons) nsw reg no 6582 Jon Pizey BArch nsw reg no 6567

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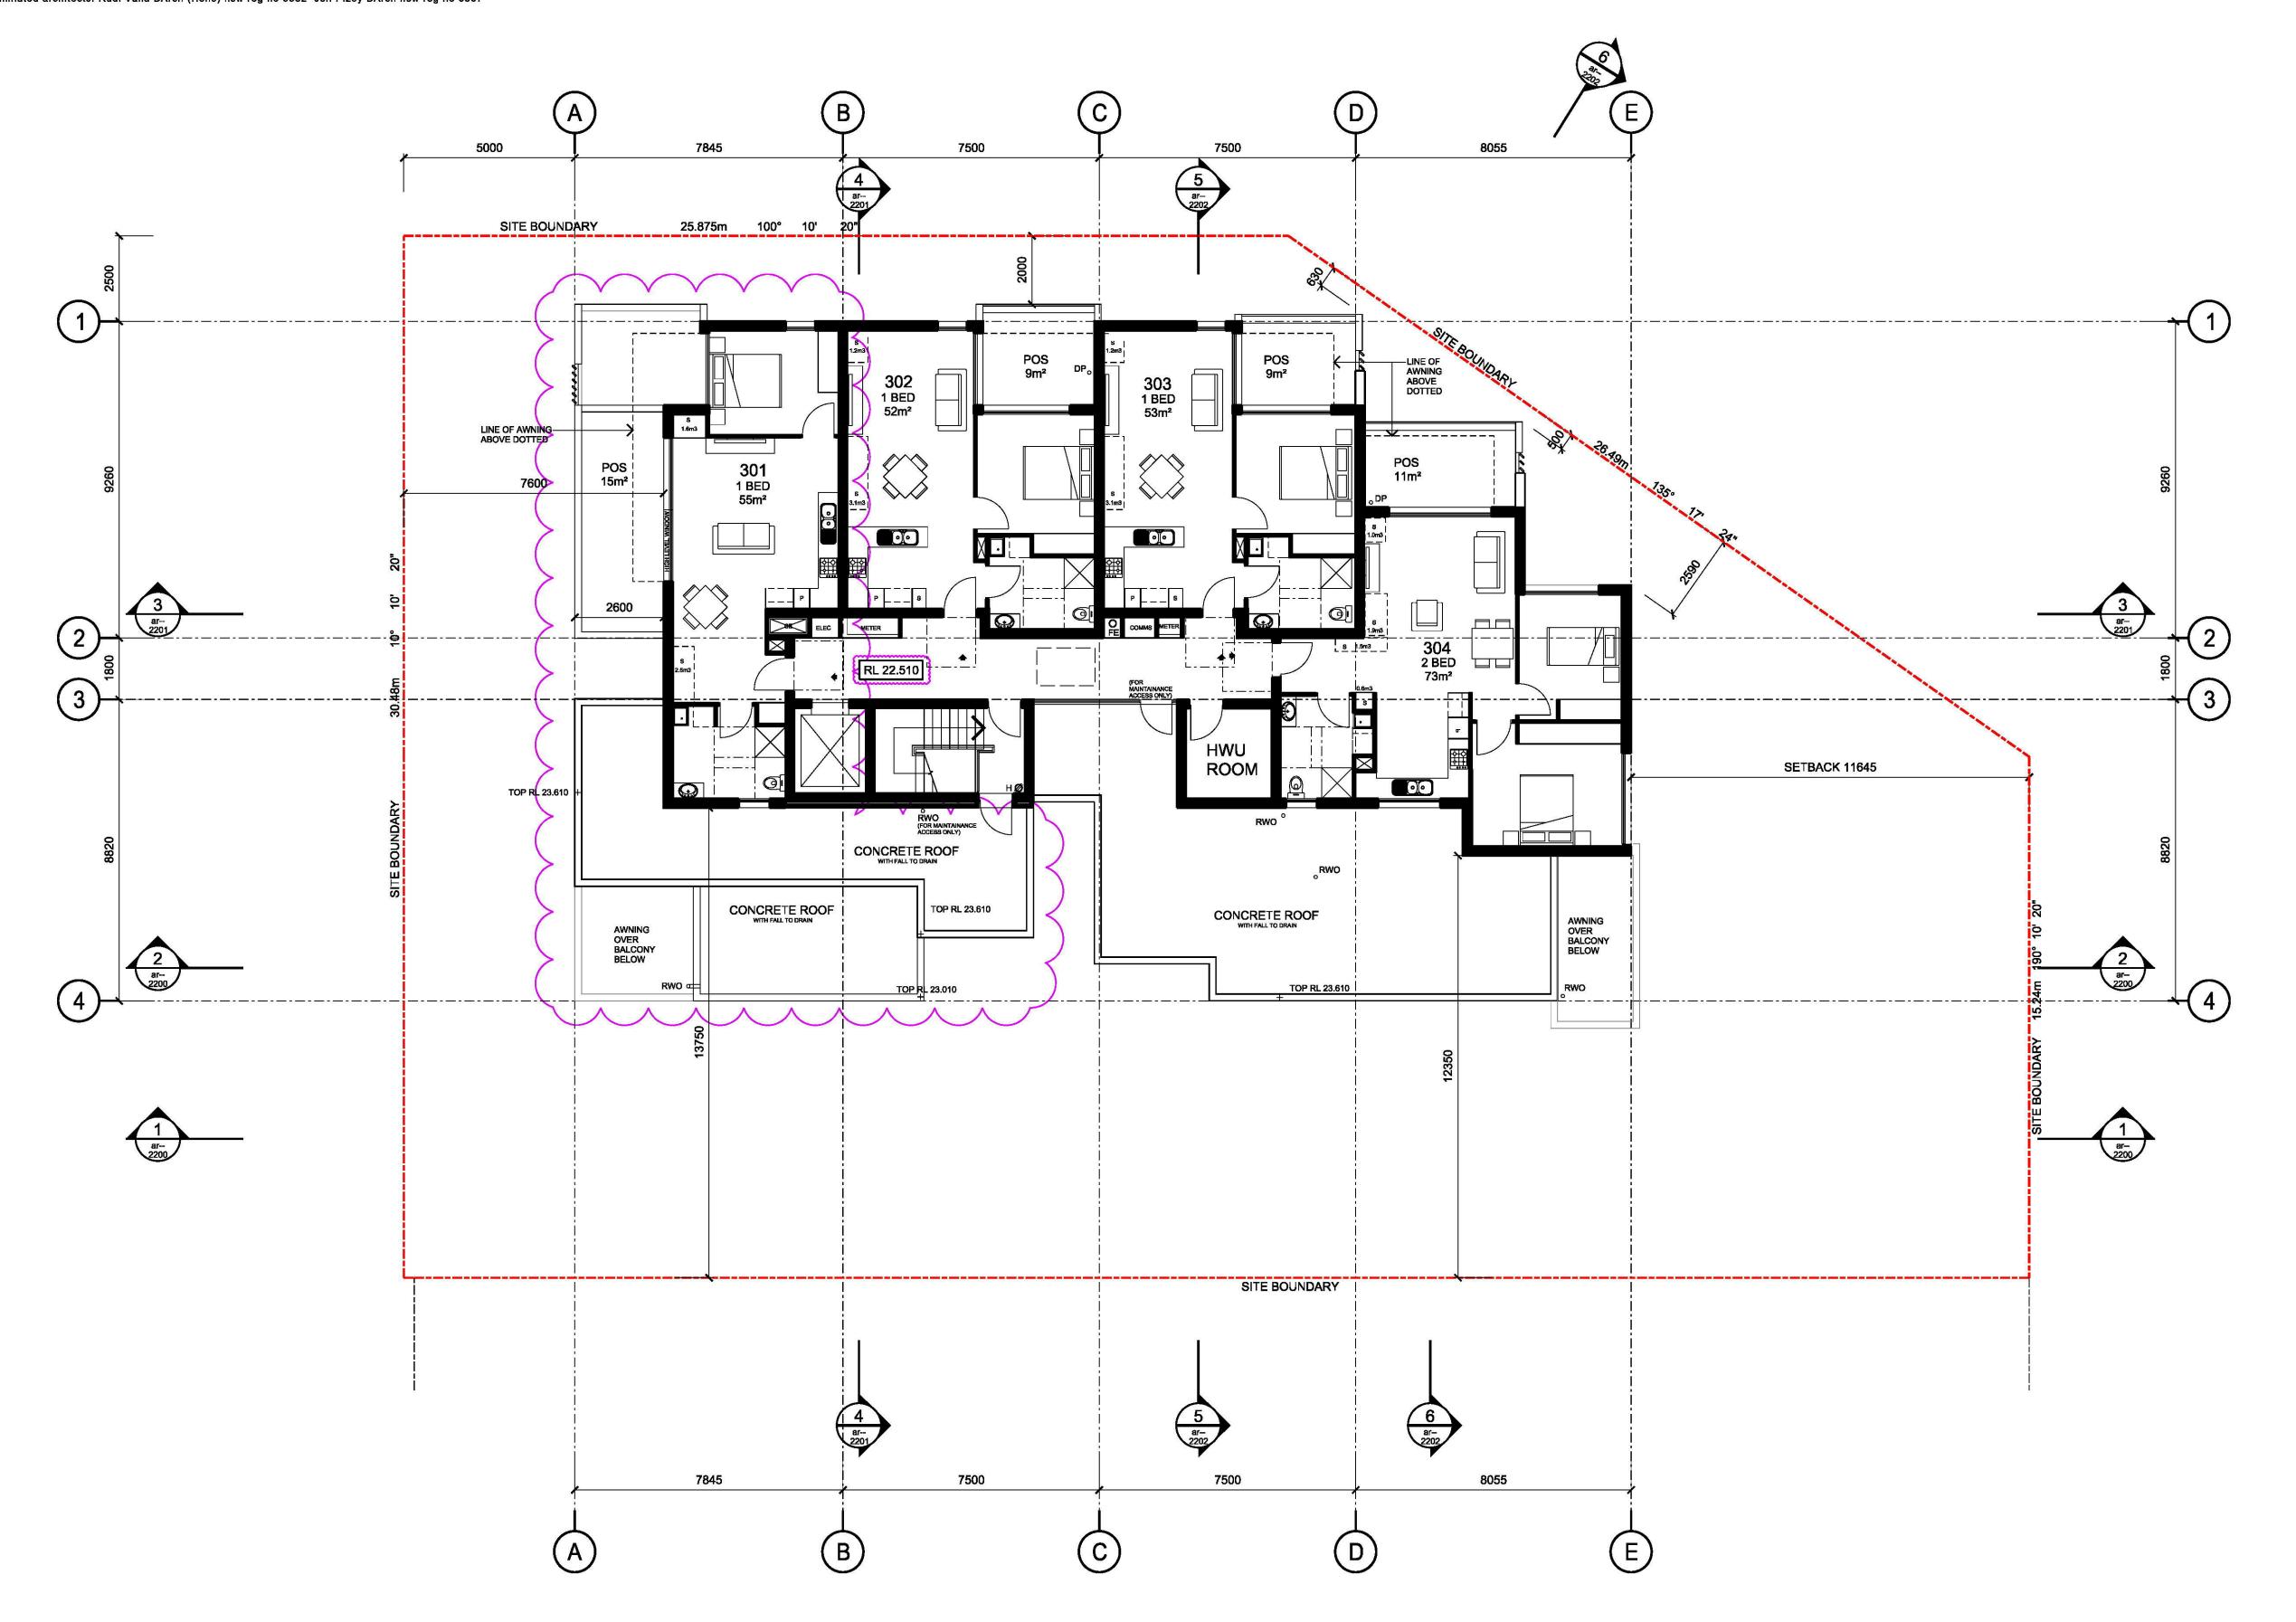
a03

level 2 plan

ar--1203

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| a1 | 1:100 | wi | 4477-0 |

nominated architects: Rudi Valla BArch (Hons) nsw reg no 6582 Jon Pizey BArch nsw reg no 6567



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amendments no. date amendment A01 21/09/18 DA SUBMISSION WJ WJ MN MN A02 29/04/19 UNIT 301 UPDATED north point

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level 3 plan

| original | scale | drawn | project no. |
|------------|-------|-------|-------------|
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| drawing no |). | 10 | rev no. |

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nominated architects: Rudi Valla BArch (Hons) nsw reg no 6582 Jon Pizey BArch nsw reg no 6567

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planning, urban design, architecture, landscape architecture, interior design

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project/client residential flat building Lot1 D.P.830369, &Lot 30 D.P.2633, 18-20 irving street, parramatta



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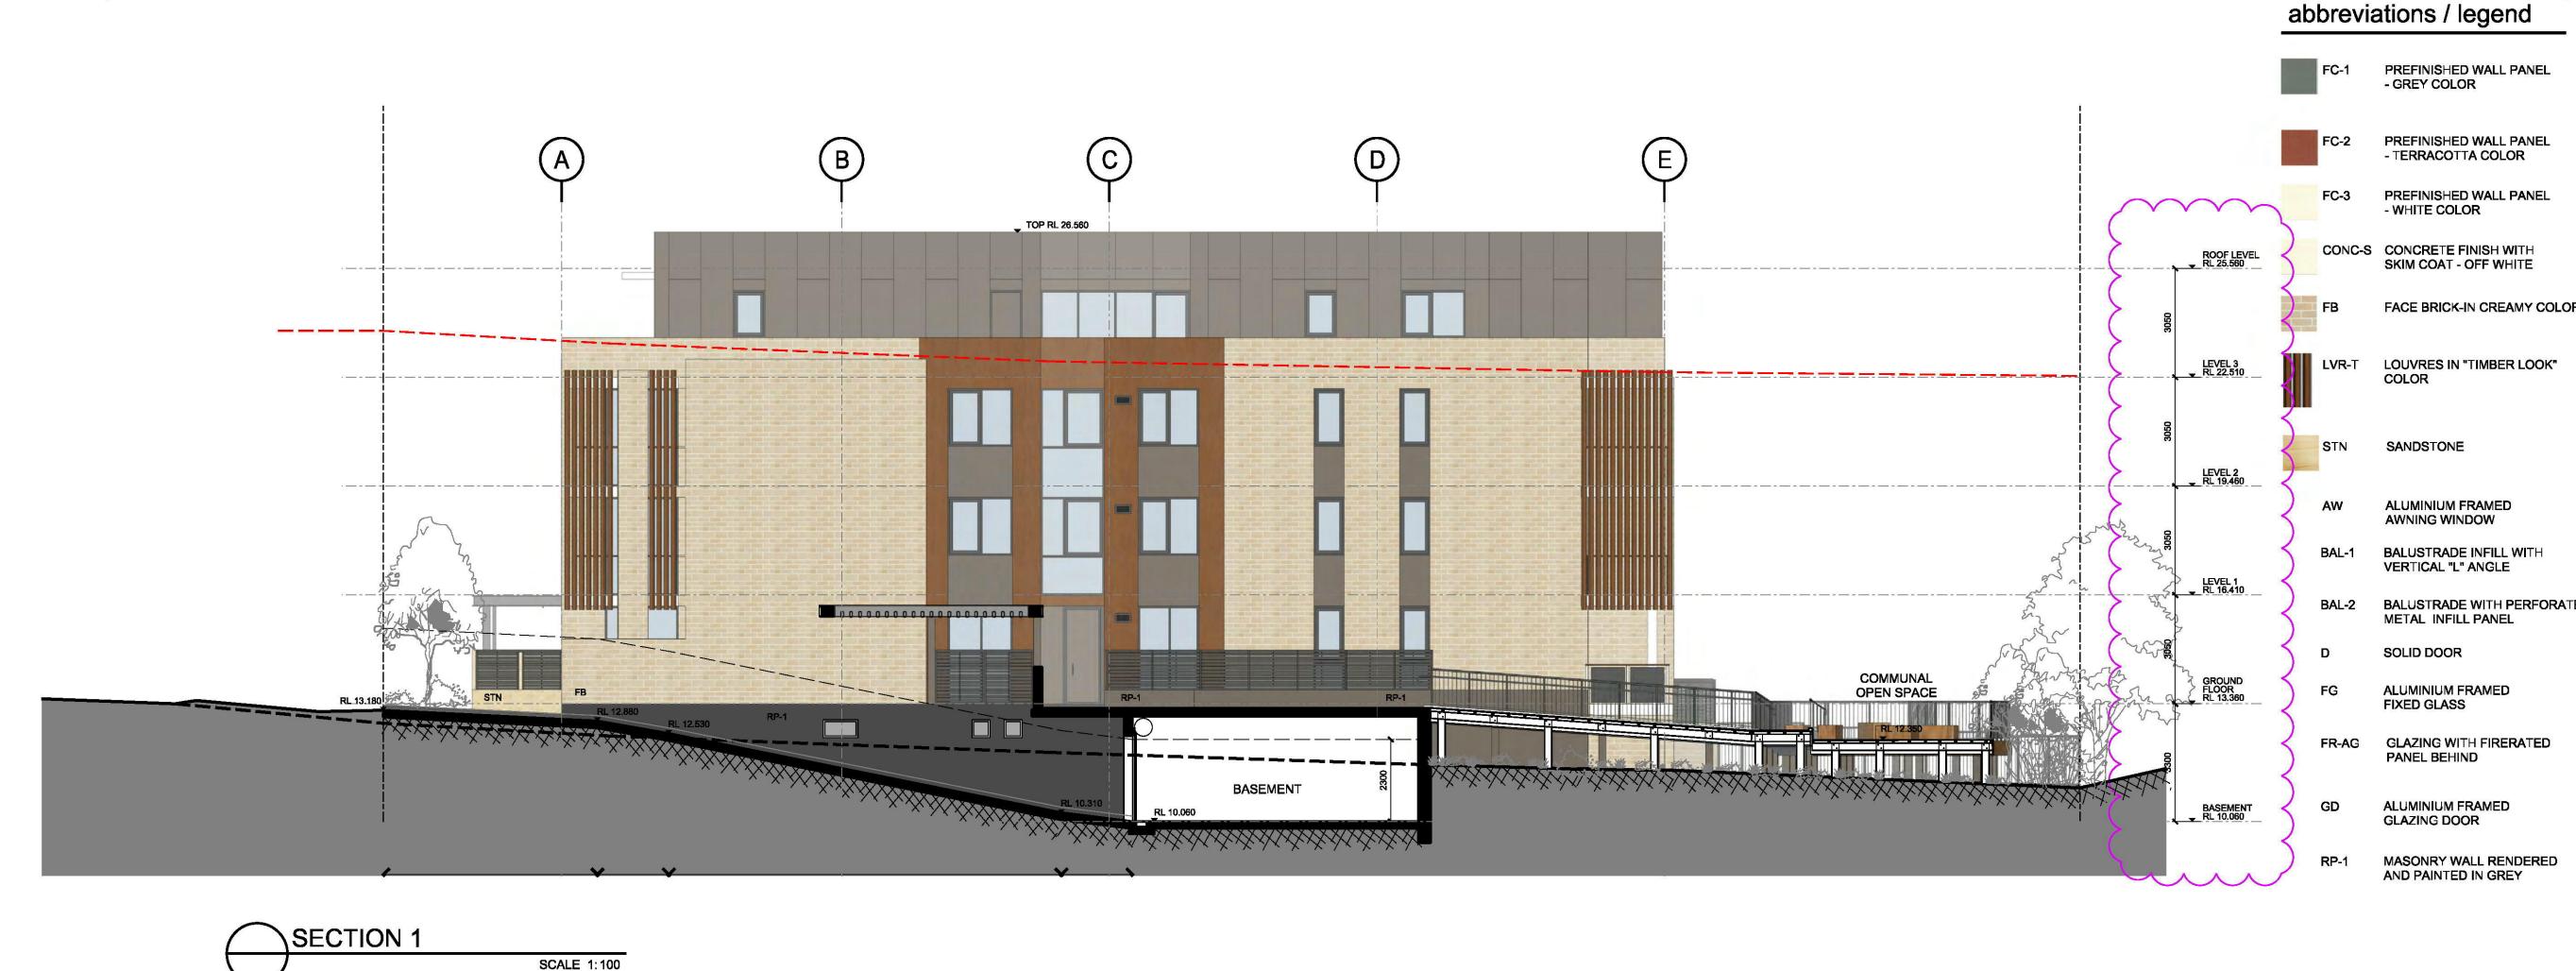


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roof plan

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nominated architects: Rudi Valla BArch (Hons) nsw reg no 6582 Jon Pizey BArch nsw reg no 6567





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planning, urban design, architecture, landscape architecture, interior design

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5
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section 1 & 2

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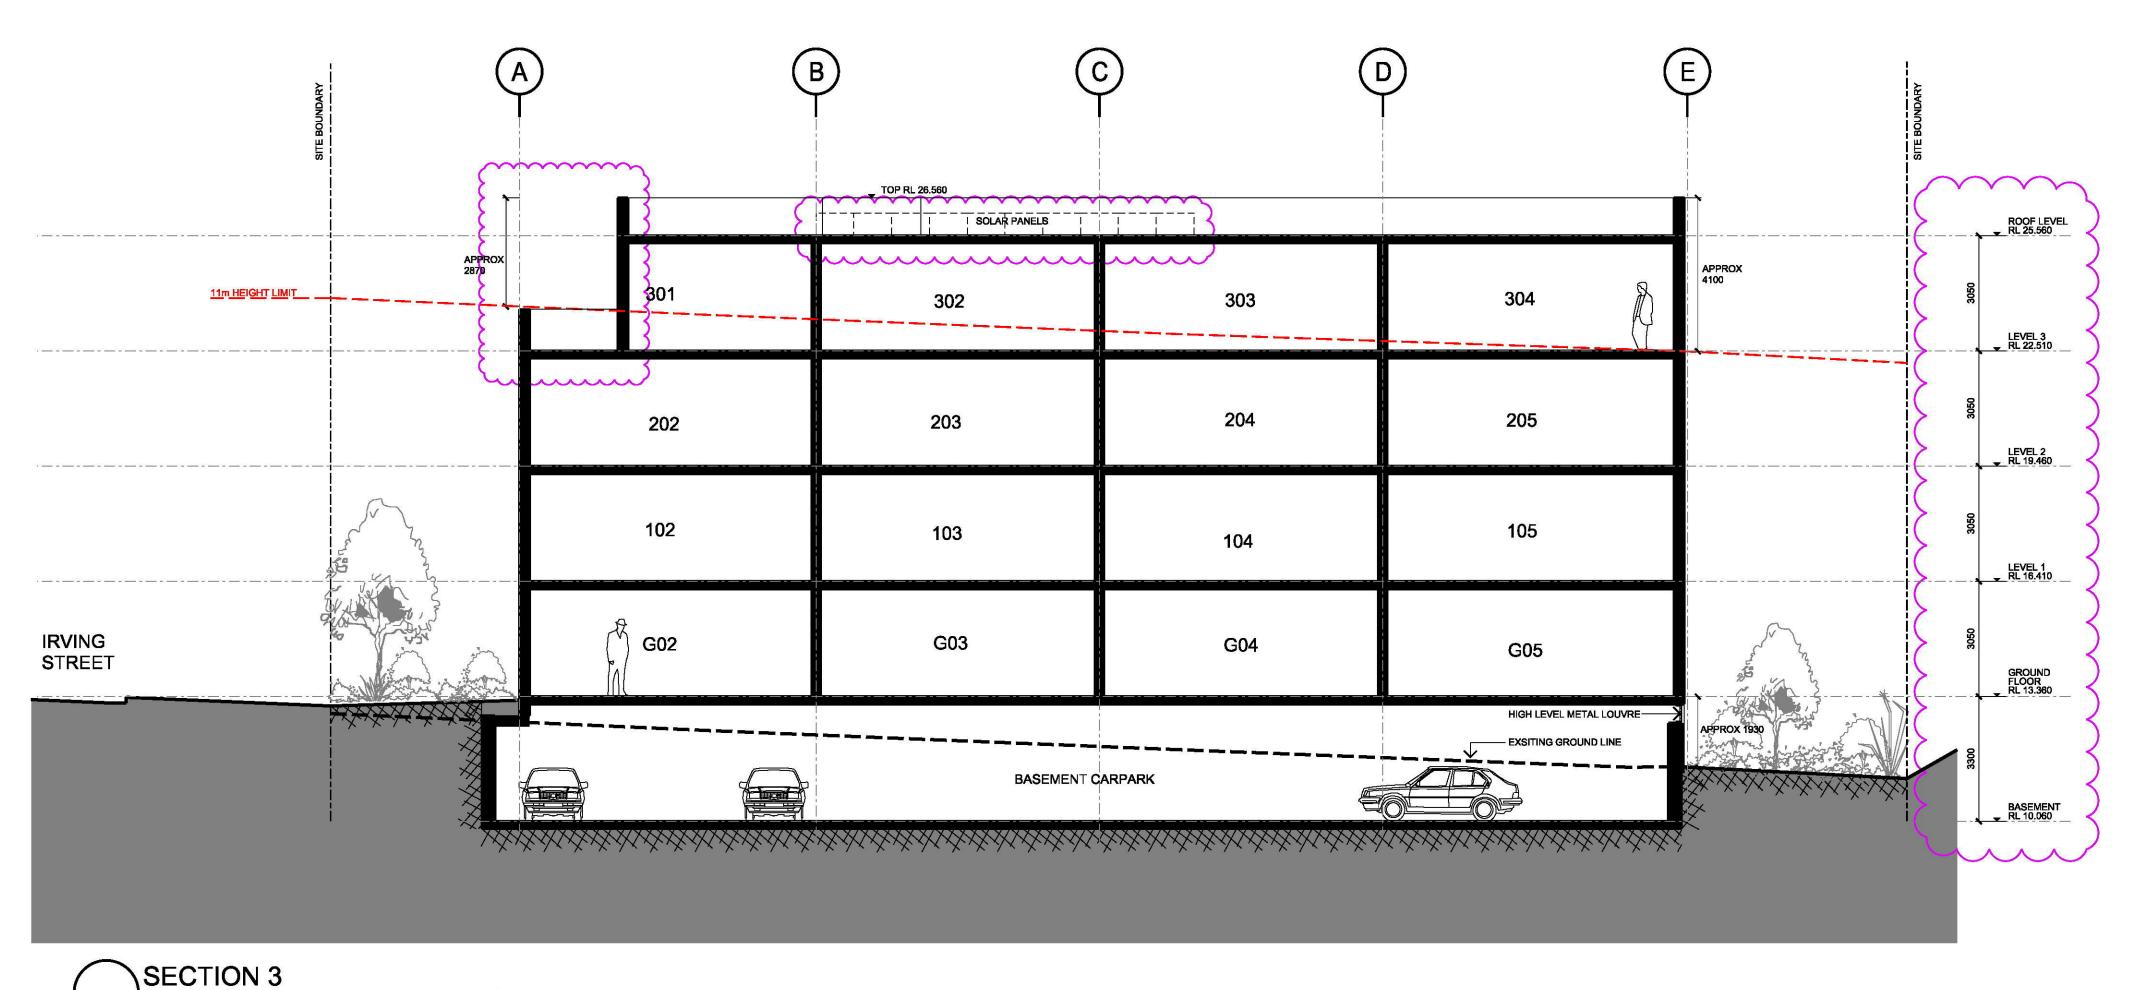
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SCALE 1:100

nominated architects: Rudi Valla BArch (Hons) nsw reg no 6582 Jon Pizey BArch nsw reg no 6567

SCALE 1:100

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abbreviations / legend PREFINISHED WALL PANEL - GREY COLOR PREFINISHED WALL PANEL - TERRACOTTA COLOR PREFINISHED WALL PANEL - WHITE COLOR CONC-S CONCRETE FINISH WITH SKIM COAT - OFF WHITE FACE BRICK-IN CREAMY COLOR LOUVRES IN "TIMBER LOOK" COLOR SANDSTONE ALUMINIUM FRAMED AWNING WINDOW **BALUSTRADE INFILL WITH** VERTICAL "L" ANGLE BALUSTRADE WITH PERFORATED METAL INFILL PANEL SOLID DOOR ALUMINIUM FRAMED **FIXED GLASS** GLAZING WITH FIRERATED PANEL BEHIND

ALUMINIUM FRAMED

AND PAINTED IN GREY

GLAZING DOOR

GD

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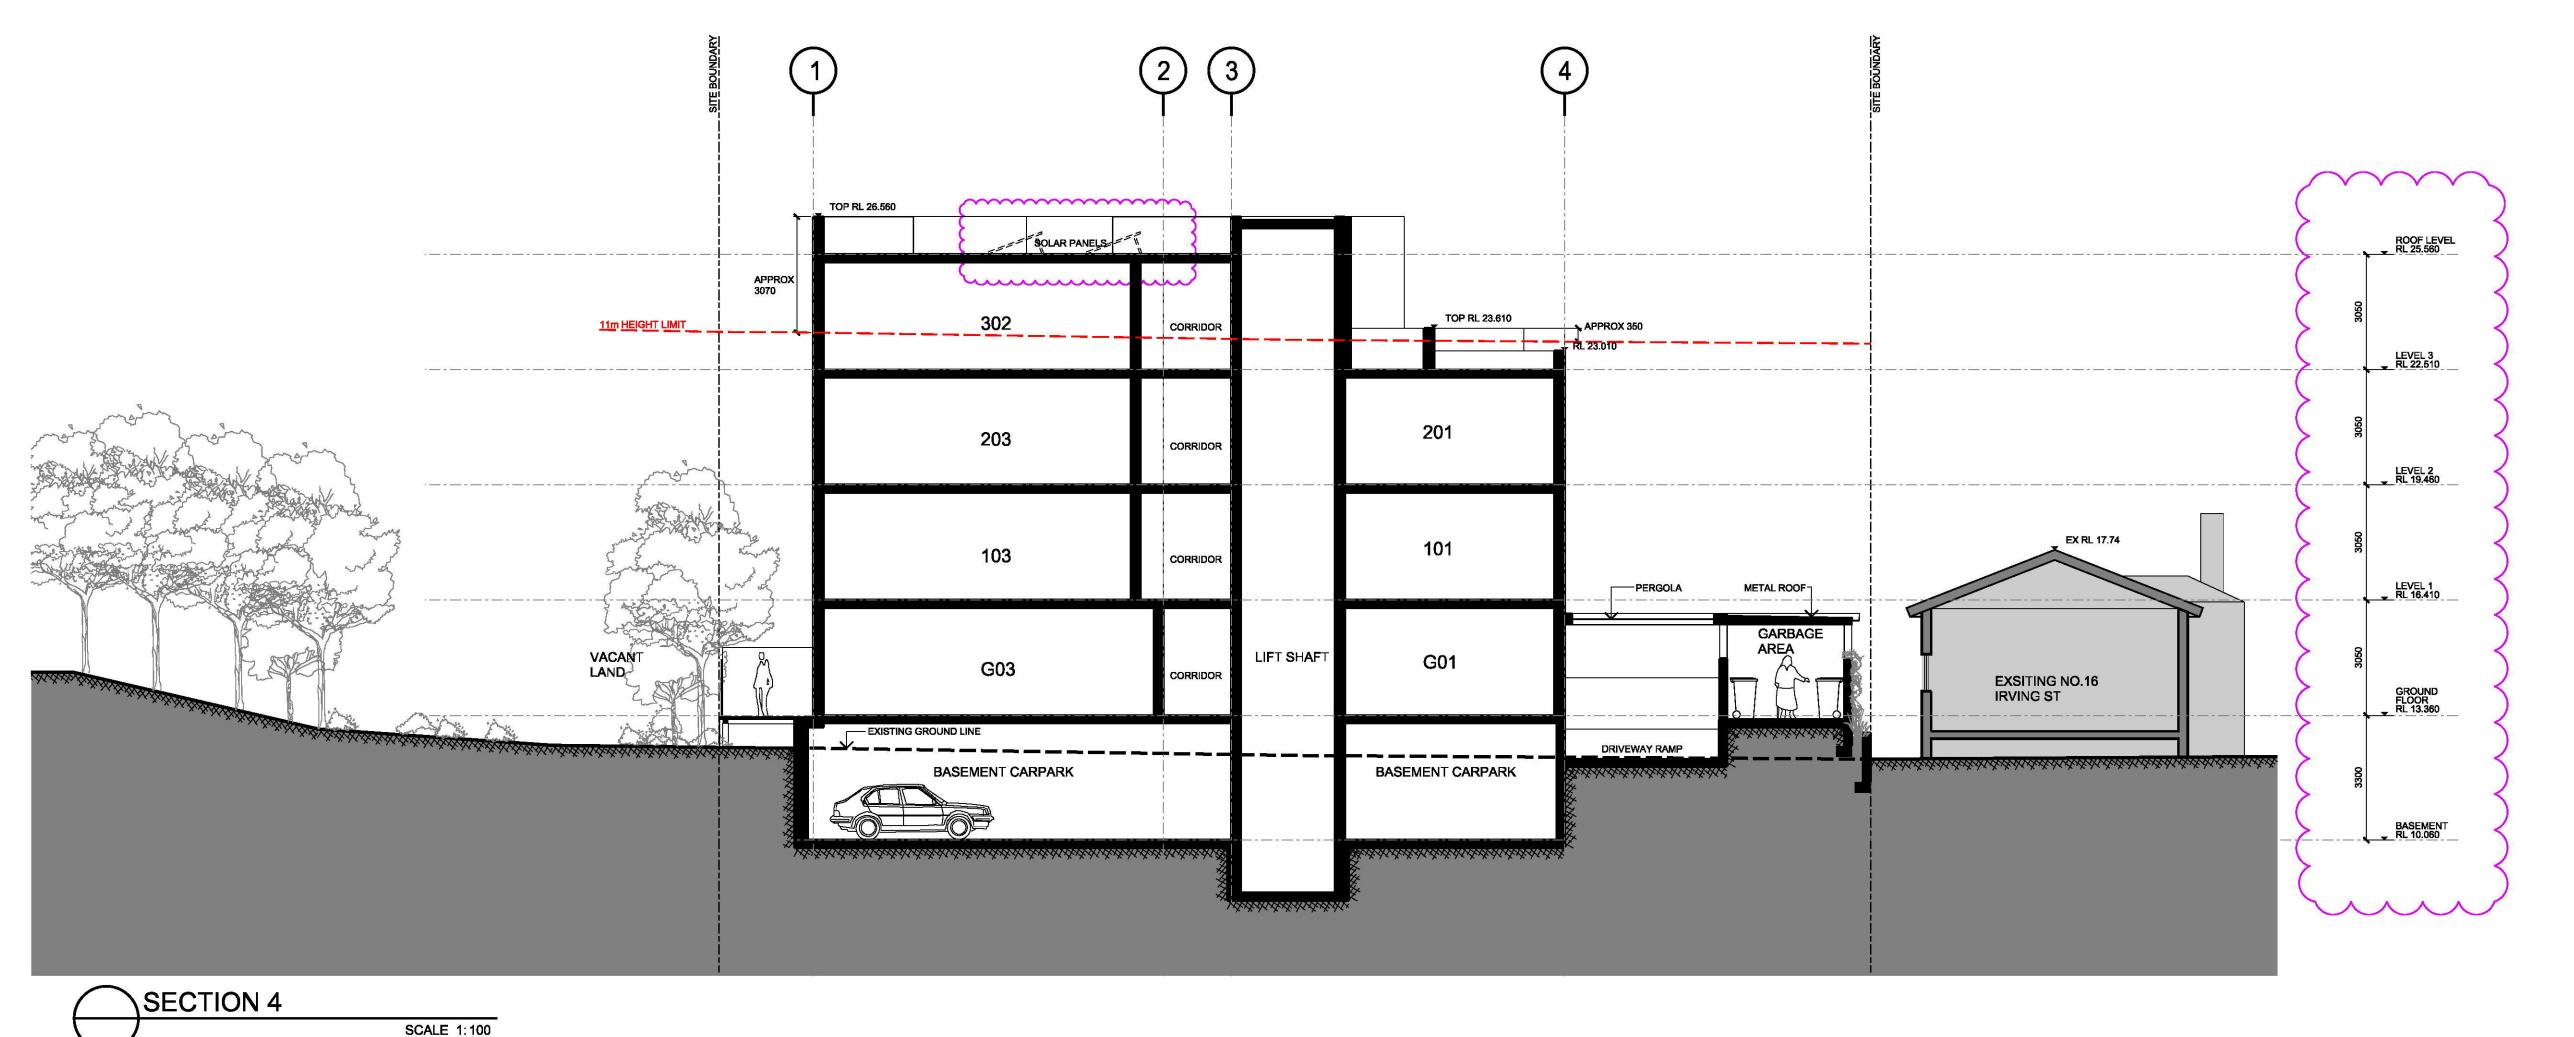


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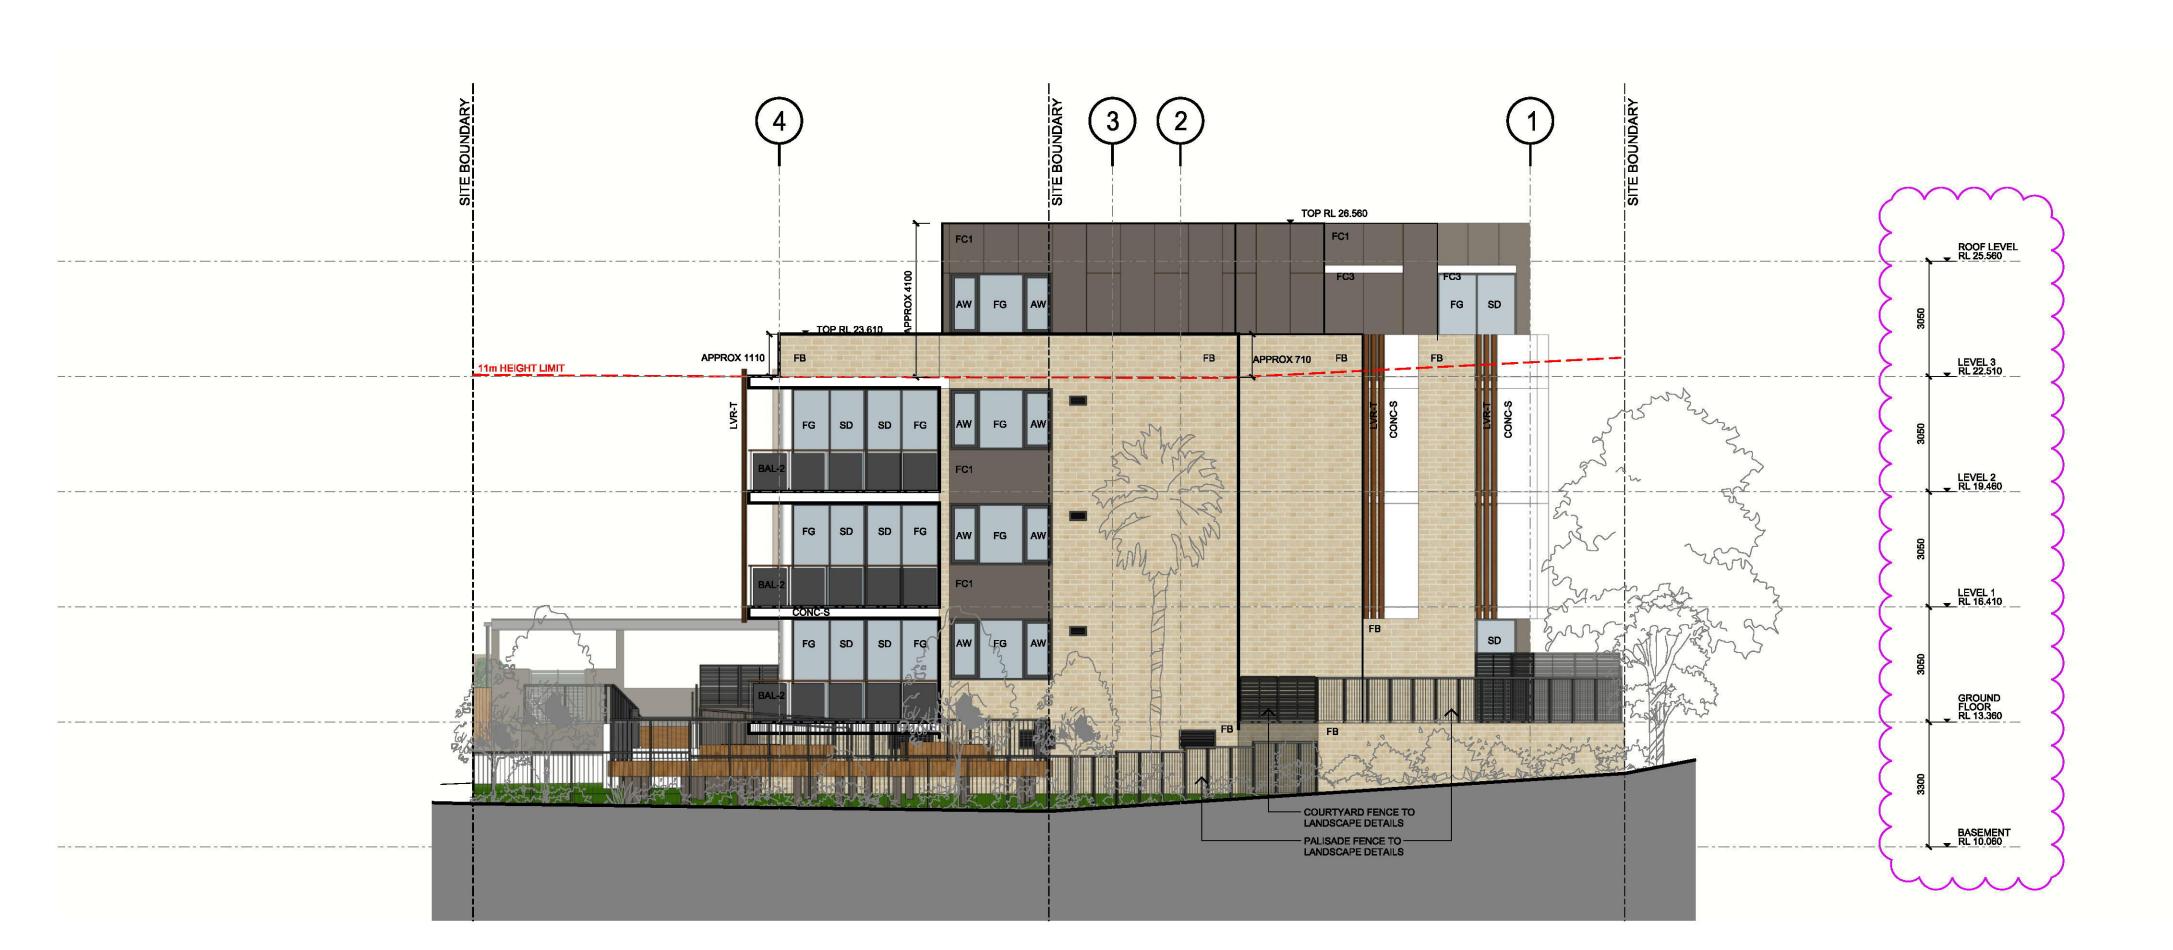
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ENGINEERS







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abbreviations / legend

PREFINISHED WALL PANEL - GREY COLOR

PREFINISHED WALL PANEL - TERRACOTTA COLOR

PREFINISHED WALL PANEL - WHITE COLOR

> CONC-S CONCRETE FINISH WITH SKIM COAT - OFF WHITE

FACE BRICK-IN CREAMY COLOR

LOUVRES IN "TIMBER LOOK" COLOR

SANDSTONE

ALUMINIUM FRAMED AWNING WINDOW

BALUSTRADE INFILL WITH VERTICAL "L" ANGLE

BAL-2 BALUSTRADE WITH PERFORA METAL INFILL PANEL

SOLID DOOR

ALUMINIUM FRAMED **FIXED GLASS**

GLAZING WITH FIRERATED PANEL BEHIND

GD ALUMINIUM FRAMED **GLAZING DOOR**

MASONRY WALL RENDERED AND PAINTED IN GREY

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residential flat building Lot1 D.P.830369, &Lot 30 D.P.2633,



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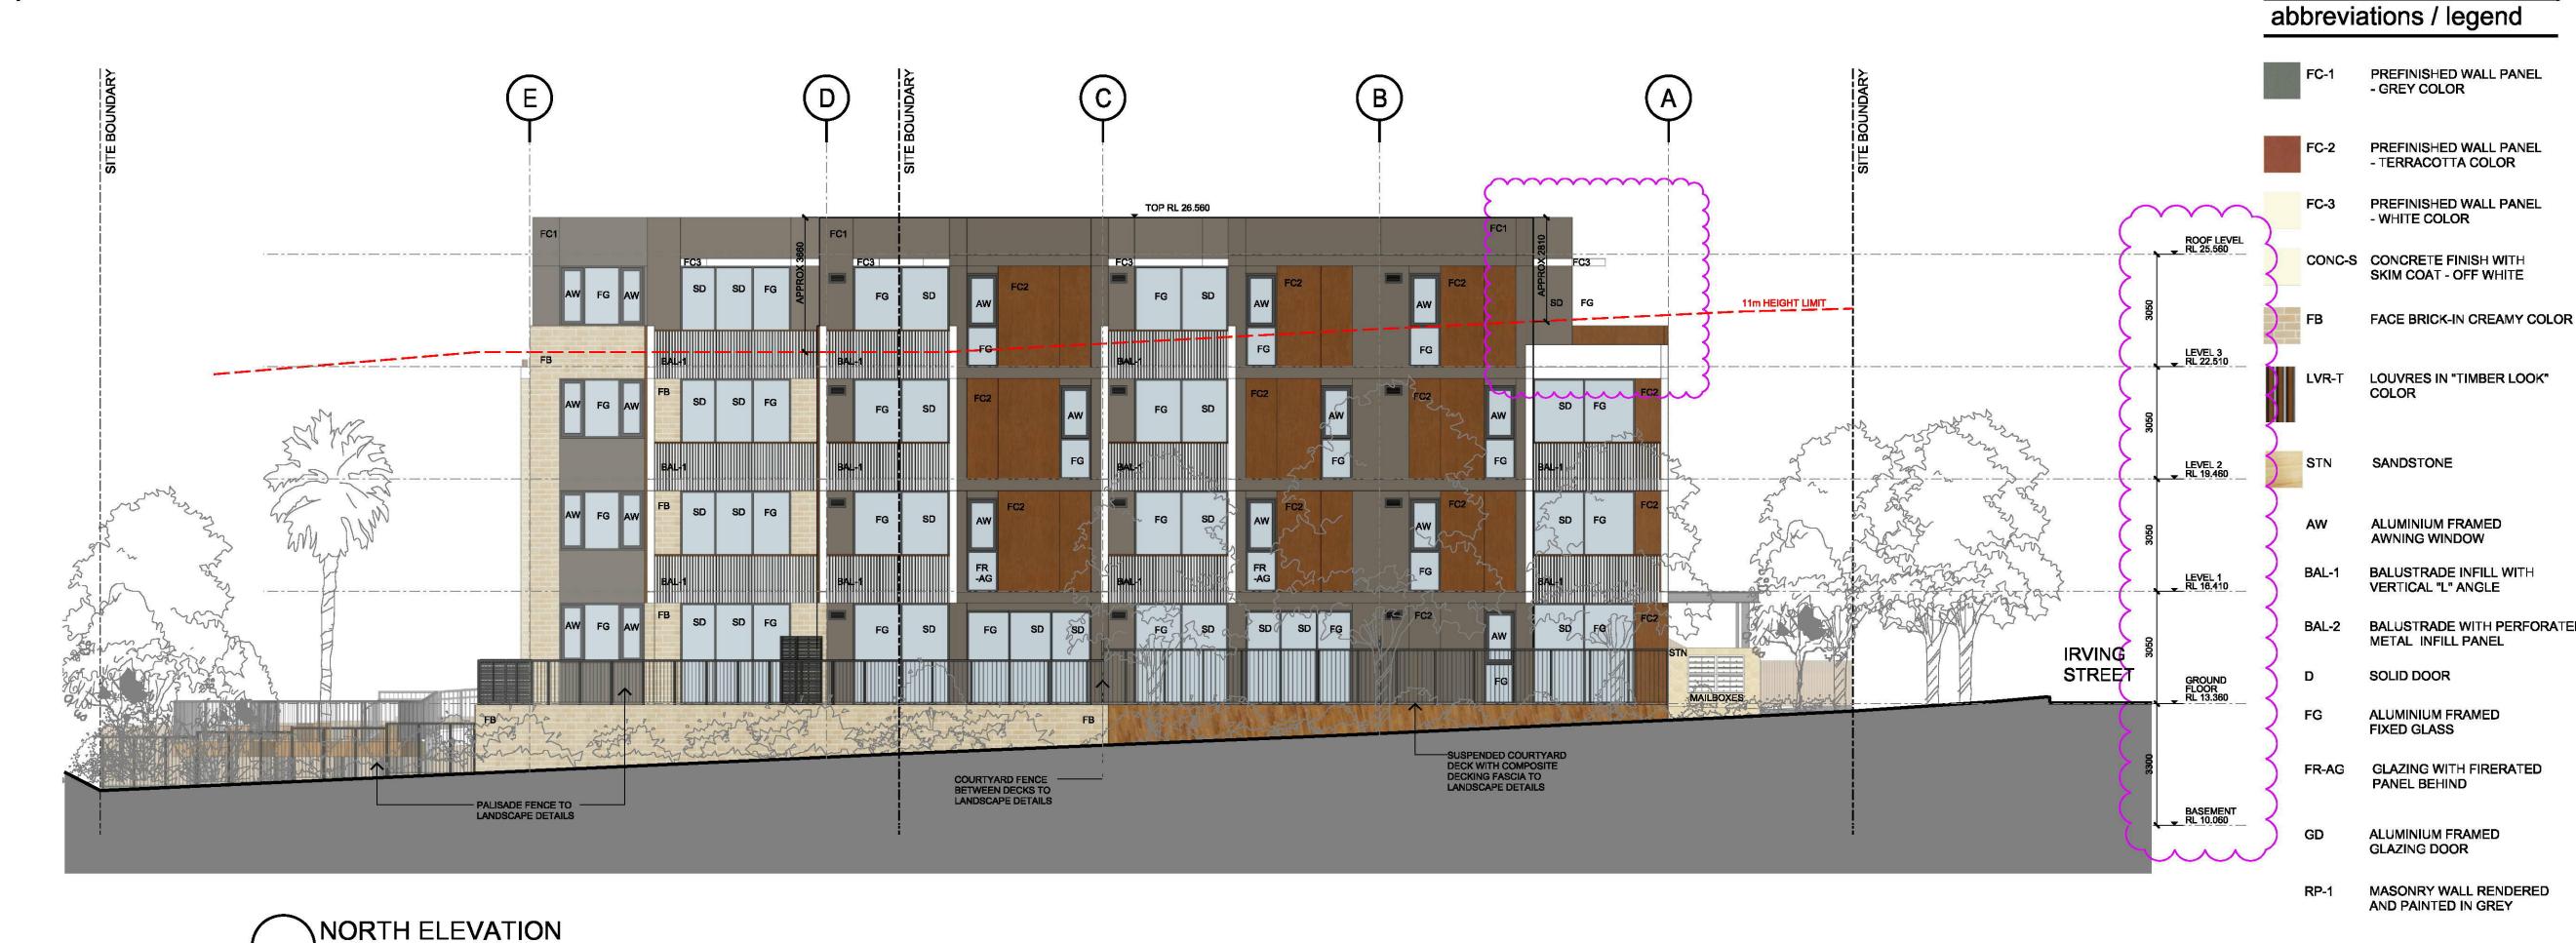


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west and east elevations

da issue project no. 4477-00 rev no. ar--2600 a03

nominated architects: Rudi Valla BArch (Hons) nsw reg no 6582 Jon Pizey BArch nsw reg no 6567



TOP RL 26.560 FC3 FG FG GD TOP RL 23.010 LEVEL 3 RL 22.510 LEVEL 2 RL 19.460 METAL DECK ROOF TO GARBAGE AREA SD FG TIMBER PALING FENCE TO LANDSCAPE DETAILS RETAINING WALL TO ENGINEER'S DETAILS BASEMENT RL 10.060

SOUTH ELEVATION **SCALE 1:100**

SCALE 1:100

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north and south elevations

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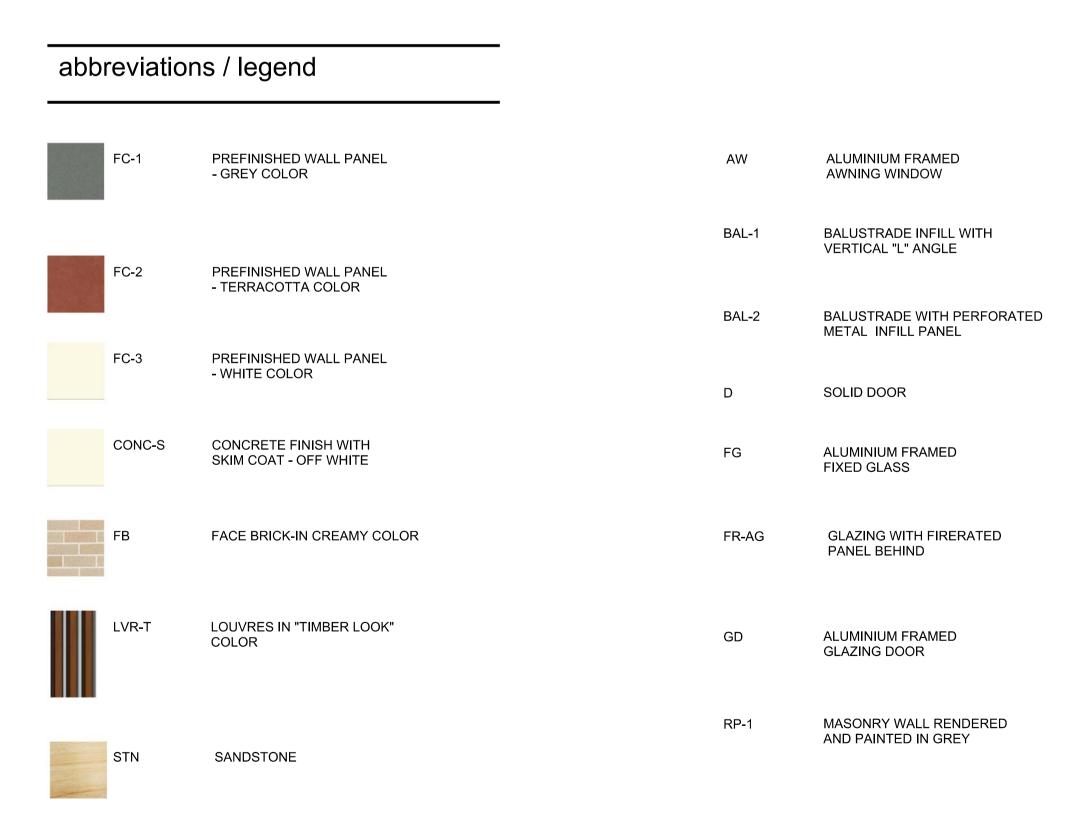
WEST ELEVATION - VIEW FROM IRVING STREET

FC-3



LVR-T

NORTH ELEVATION



Residential Flat Building, Parramatta

Lot 1 D.P. 830369 & Lot 30 D.P. 2633, 18-20 Irving Street, Parramatta

sample board

da issue

plotted by: mng

FC-2

arsk8000

Comply with Adaptable housing(AS4299-1995) Main Bedroom Living room&Dining room **Interior General** at least one bedroom of area sufficient to accommodate queen size bed circulation space of min 2250 mm diameter and wardrobe and circulation space requirement of AS1428.2 internal door to have 820mm min internal corridors min width 1000mm Bathroom Laundry compliance with AS1428.1 for door approaches bathroom area to comply with AS1428.1 circulation at doors to comply with AS1428.1 shower recess-no hob 1160*1100 to comply with AS1428.1 window sills at max.730mm abve floor level to living & 600mm above floor adequate circulation space in front of or beside appliances(min 1550mm grabrail in shower to comply with AS1428.1 level to bedroom areas depth) where alothes line is provided, an accessible path of travel to this folding seat in shower to comply with AS1428.1 Kitchen linen cupboard min.600 wide with adjustable shelving min width 2.7m (1550mm clear between benches) washbasin with clearances to cpmply with AS1428.1 800mm length worksurface adjustable in height750-850 Toilet Garbage bin in accessible location visitable toilet or accessible toilet refrigerator adjacent to work surface worksurface min 800lenth adjucent to cooktop at the same height provision to comply with AS1428.1 Oven located adjacent to an adjustable height or replaceable work surface location of WC pan at correct distance from fixed walls

3 PRE-ADAPTED

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4 POST-ADAPTED

SCALE 1:

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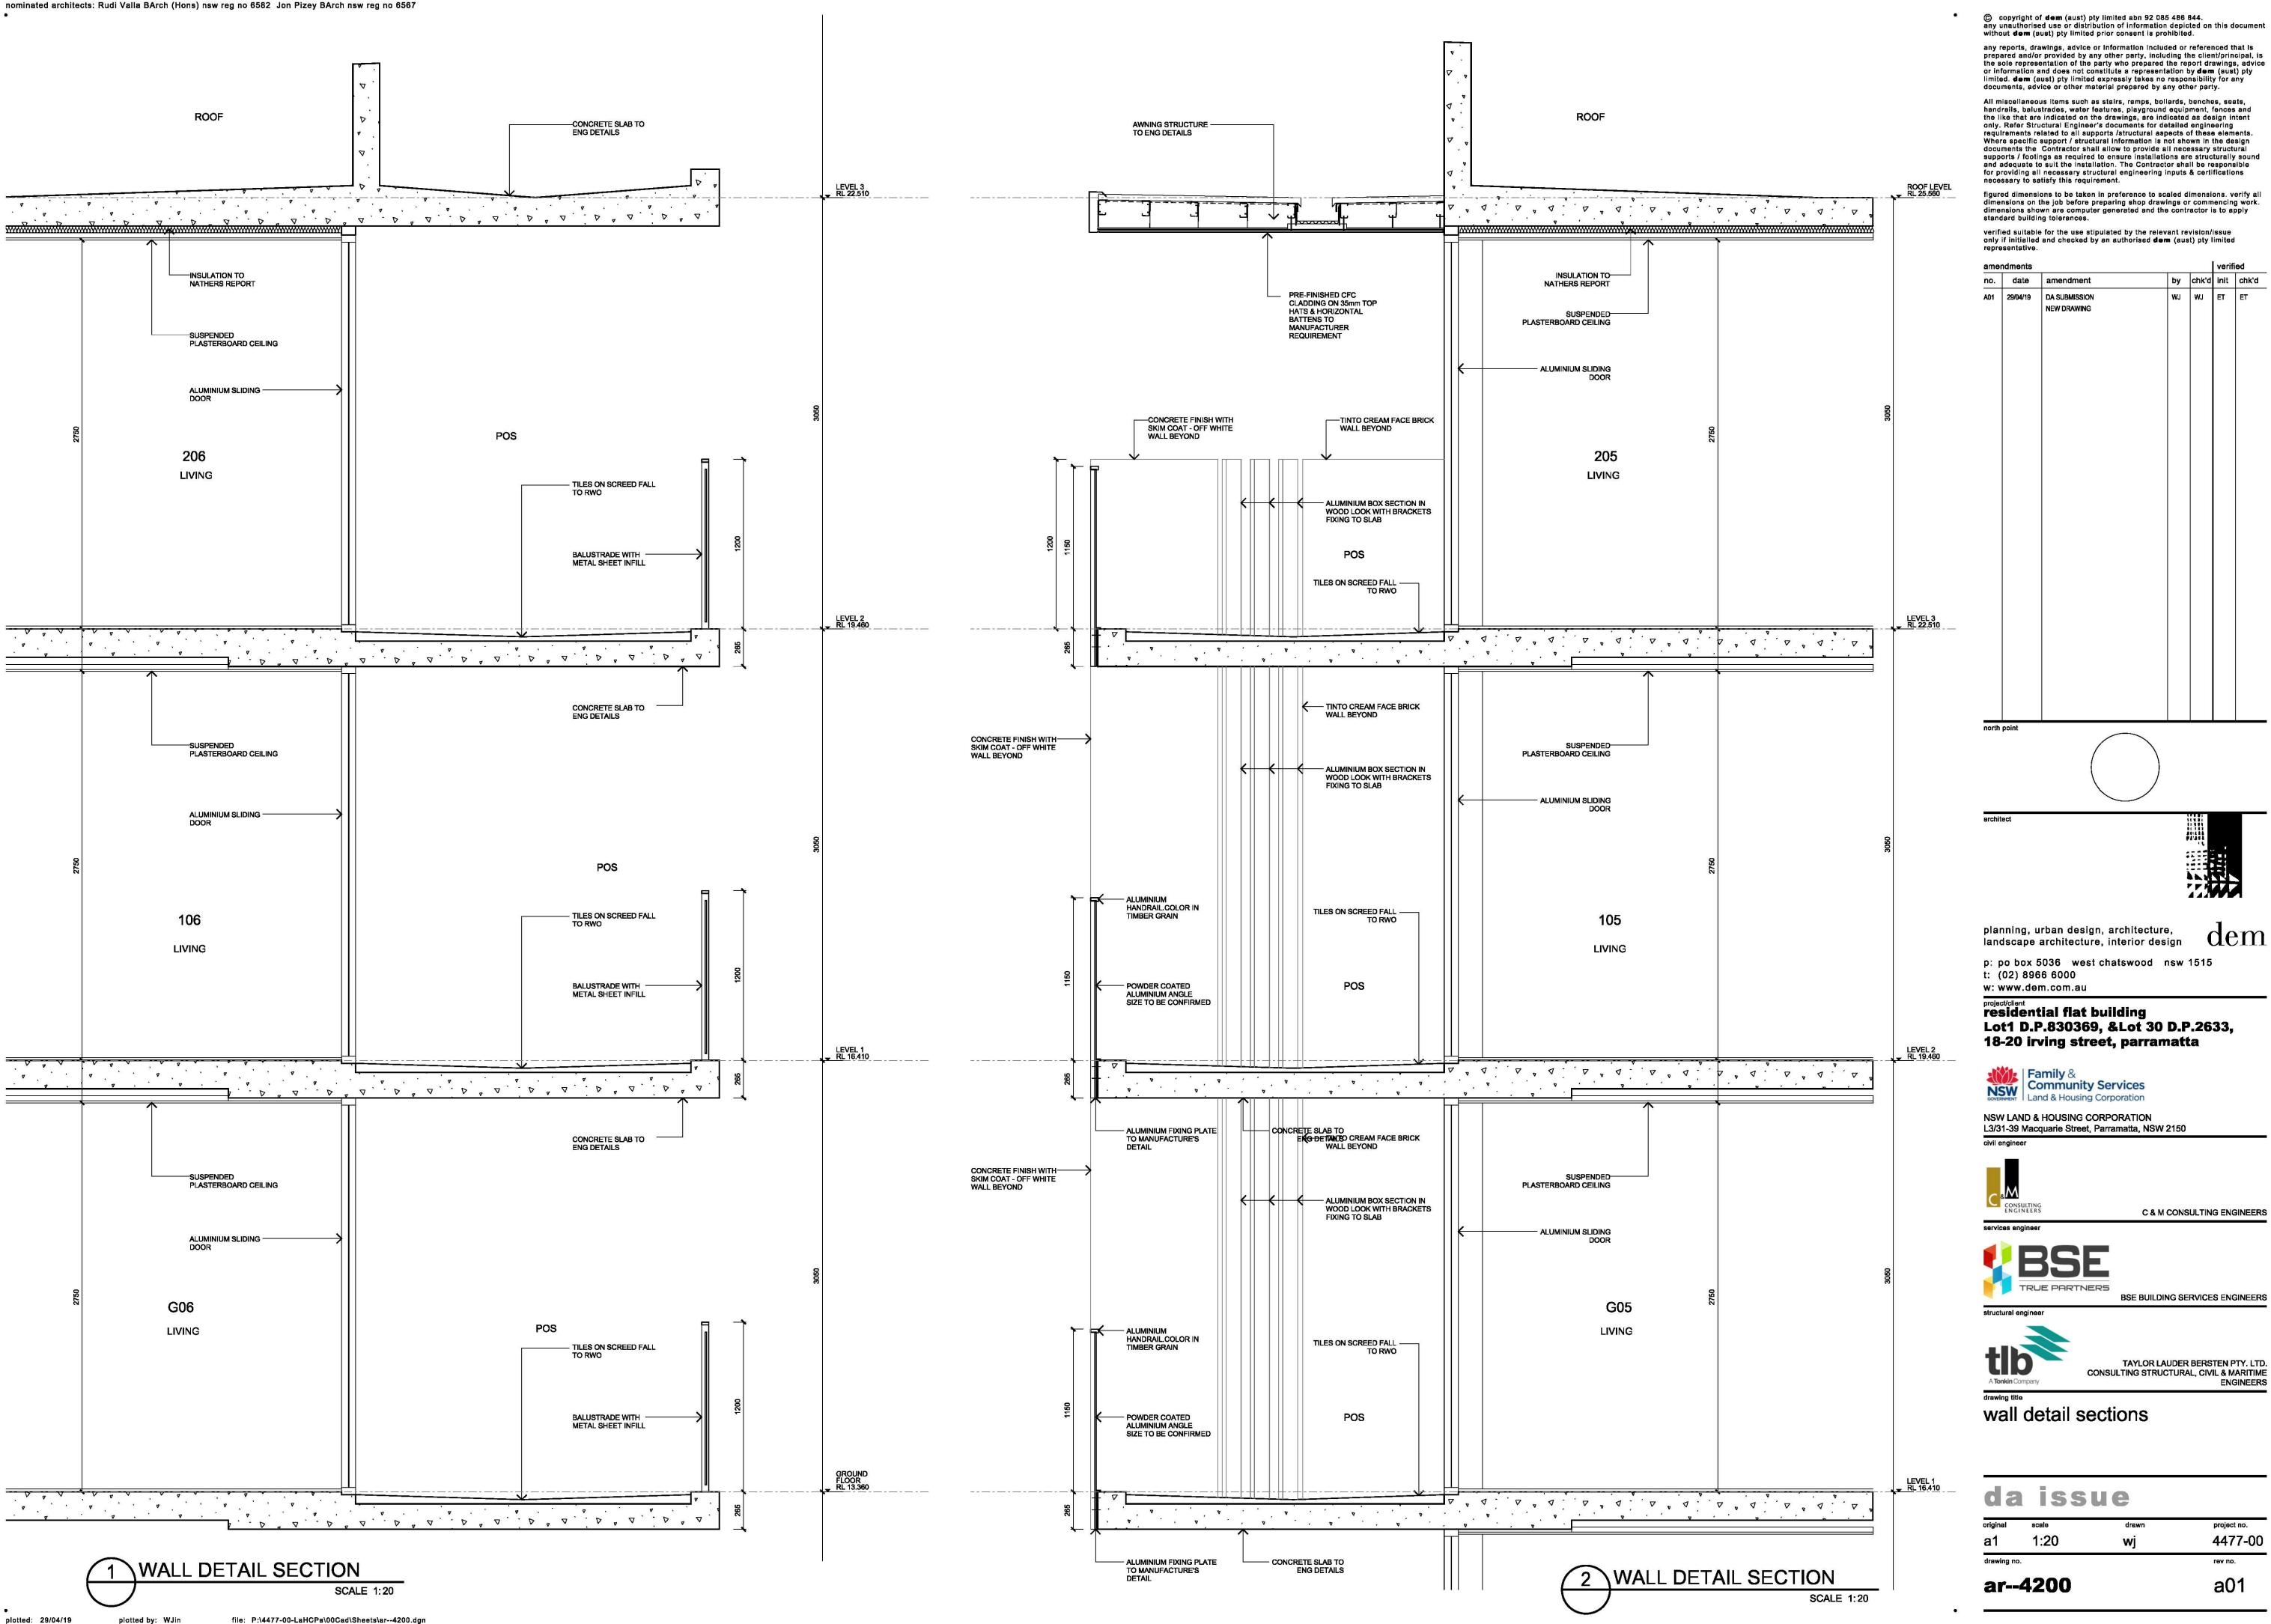
Adaptable Unit Layout

da issue

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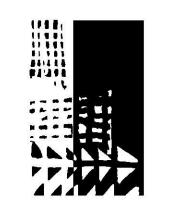
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BSE BUILDING SERVICES ENGINEERS

TAYLOR LAUDER BERSTEN PTY. LTD.

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Social Housing Development, Parramatta Lot 1 D.P. 830369 & Lot 30 D.P. 2633, 18-20 Irving Street, Parramatta

da issue

RESIDENTIAL FLAT BUILDING 18-20 IRVING STREET PARRAMATTA

LANDSCAPE ARCHITECTURAL DRAWINGS

| PLAN | T LIS T | | | | | |
|-------|----------------------------------|------------------|------------------|----------|--|---------|
| | SOCIAL HOUS | SING DEVELOP | MENT, PARRA | MATTA | | |
| Code | Botanic Name | Common Name | Size | Pot Size | Rate | Quantit |
| TREES | | • | | | | |
| Er | Elaeocarpus reticulatus | Blueberry Ash | 6x4m | 75L | N/A | 9 |
| Ер | Eucalyptus punctata | Grey Gum | 12x8m | 25L | N/A | 2 |
| Li | Lagerstroemia indica | Crape Myrtle | 6X6m | 25L | N/A | 4 |
| MI | Melaleuca lineariifolia | Snow in Summer | 4x5m | 25L | N/A | 1 |
| TI | Tristaniopsis laurina 'Luscious' | Water Gum | 8x5m | 75L | N/A | 5 |
| SHRUE | BS | | | | | |
| Bs | Banksia spinulosa | Hairpin Banksia | 1.5x1m | 200mm | 1000mm | 6 |
| Bmj | Buxus microphylla | Japanese Box | Trim to 0.5x0.5m | 200mm | 500mm | ~27 |
| Cl | Callistemon linearifolius | Bottlebrush | 2.5x1m | 200mm | 1000mm | 33 |
| De | Doryanthes excesior | Gymea lily | 1.5x1.5m | 200mm | 1000mm | |
| Ga | Gardenia augusta | Gardenia | 1x1m | 200mm | 500mm | 26 |
| Мр | Murraya paniculata | Orange jasmine | 1x1.2m | 200mm | 1000mm | 5 |
| Pg | Photinia glabra 'Red Robin' | Photinia | 0.3x1m | 200mm | 1000mm | -21 |
| Sr | Strelitzia reginae | Bird of Paradise | 1x1m | 200mm | 1000mm | 44 |
| Sp | Syzigium Pinnacle | Pinnacle | 7x1.2m | 200mm | 1000mm | 10 |
| Ss | Syzygium smithii | Lilly Pilly | 1x1.2m | 200mm | 1000mm | 31 |
| Rop | Rhaphiolepis 'Oriental Pearl' | Oriental Pearl | 0.6x1m | 200mm | 750mm | 6 |
| Wfs | Westringia fruticosa Spp. | Westringia | 2x2m | 200mm | 750mm | 26 |
| GROU | NDCOVER | | • | | | * |
| DI | Dianella longifolia | Dianella | 0.8x0.5m | 150mm | 6 per/m2 | 44 |
| Dr | Dichondra repens | Kidney Weed | 0.2x1m | 150mm | 6 per/m2 | 58 |
| Hv | Hardenbergia violacea | Happy Wanderer | 0.3x2m | 150mm | 6 per/m2 | 81 |
| IJR | Liriope 'Just Right' | Just right | 0.45x0.4m | 150mm | 6 per/m2 | 119 |
| Lf | Lomandra filiformis | Mat Rush | 0.3x0.3m | 150mm | 6 per/m2 | 134 |
| LK | Lomandra 'Katrinus' | Lomandra | 1x1m | 150mm | 6per/m2 | 134 |
| LS | Lomandra Shara | Shara | 0.5x0.5m | 150mm | 6 per/m2 | 117 |
| NdB | Nandina domestica 'Blush' | Sacred Bamboo | 0.6x0.6m | 150mm | 6 per/m2 | 44 |
| PX | Philodendron 'Xanadu' | Xanadu | 0.7x0.7m | 150mm | 6 per/m2 | 51 |
| Tj | Trachelospermum Jasminoides | Star Jasmine | 1.2x1m | 150mm | 6 per/m2 | 63 |
| Vh | Viola hederacea | Native Violet | Groundcover | 150mm | 6 per/m2 | 58 |
| СШМВ | ERS | | | | | |
| Fp | Ficus pumila | Creeping fig | 3x2m | 150mm | 500mm | 11 |
| | OME | 245 | | | CC | -726 |



ISSUE DRAWING NUMBER DRAWING NAME la--cv00 A05 landscape cover sheet la--0501 landscape plan A05 la--8901 landscape details A04

GENERAL NOTES

- 1. THIS DRAWING TO BE READ IN CONJUNCTION WITH LANDSCAPE WORKS SPECIFICATION
- 2. DIMENSIONS ARE IN MILLIMETRES LEVELS SHOWN ARE IN METRES DO NOT SCALE ANY DRAWINGS
- 3. FOR ROAD DETAILS REFER TO CIVIL ENGINEERS DRAWINGS
- 4. FOR BUILDING DETAILS REFER TO ARCHITECTURAL DRAWINGS
- 5. FOR STORMWATER DRAINAGE REFER TO HYDRAULIC ENGINEERS DRAWINGS
- 6. FOR LIGHTING REFER TO ELECTRICAL **ENGINEERS DRAWINGS**
- 7. ALL SERVICES ARE TO BE CHECKED & VERIFIED ON SITE
- 8. REFER TO SURVEY PLANS BY OPUS INTERNATIONAL CONSULTANS(AUSTRALIA) PTY LTD DATED 1ST APRIL 2015 NOT ALL SURVEY INFORMATION HAS BEEN SHOWN FOR CLARITY OF DRAWING SOME DISCREPANCIES MAY OCCUR

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| A02 | 30/08/18 | FINAL COORDINATION | JB | JB | AB | АВ |
| A03 | 31/08/18 | DRAFT DA | JB | JB | AB | AB |
| A04 | 14/09/18 | DA ISSUE | JB | JB | AB | AB |
| A05 | 30/04/19 | REVISED DA ISSUE | АВ | AB | AB | АВ |
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project/client residential flat building Lot1 D.P.830369, &Lot 30 D.P.2633, 18-20 irving street, parramatta



NSW LAND & HOUSING CORPORATION L3/31-39 Macquarie Street, Parramatta, NSW 2150



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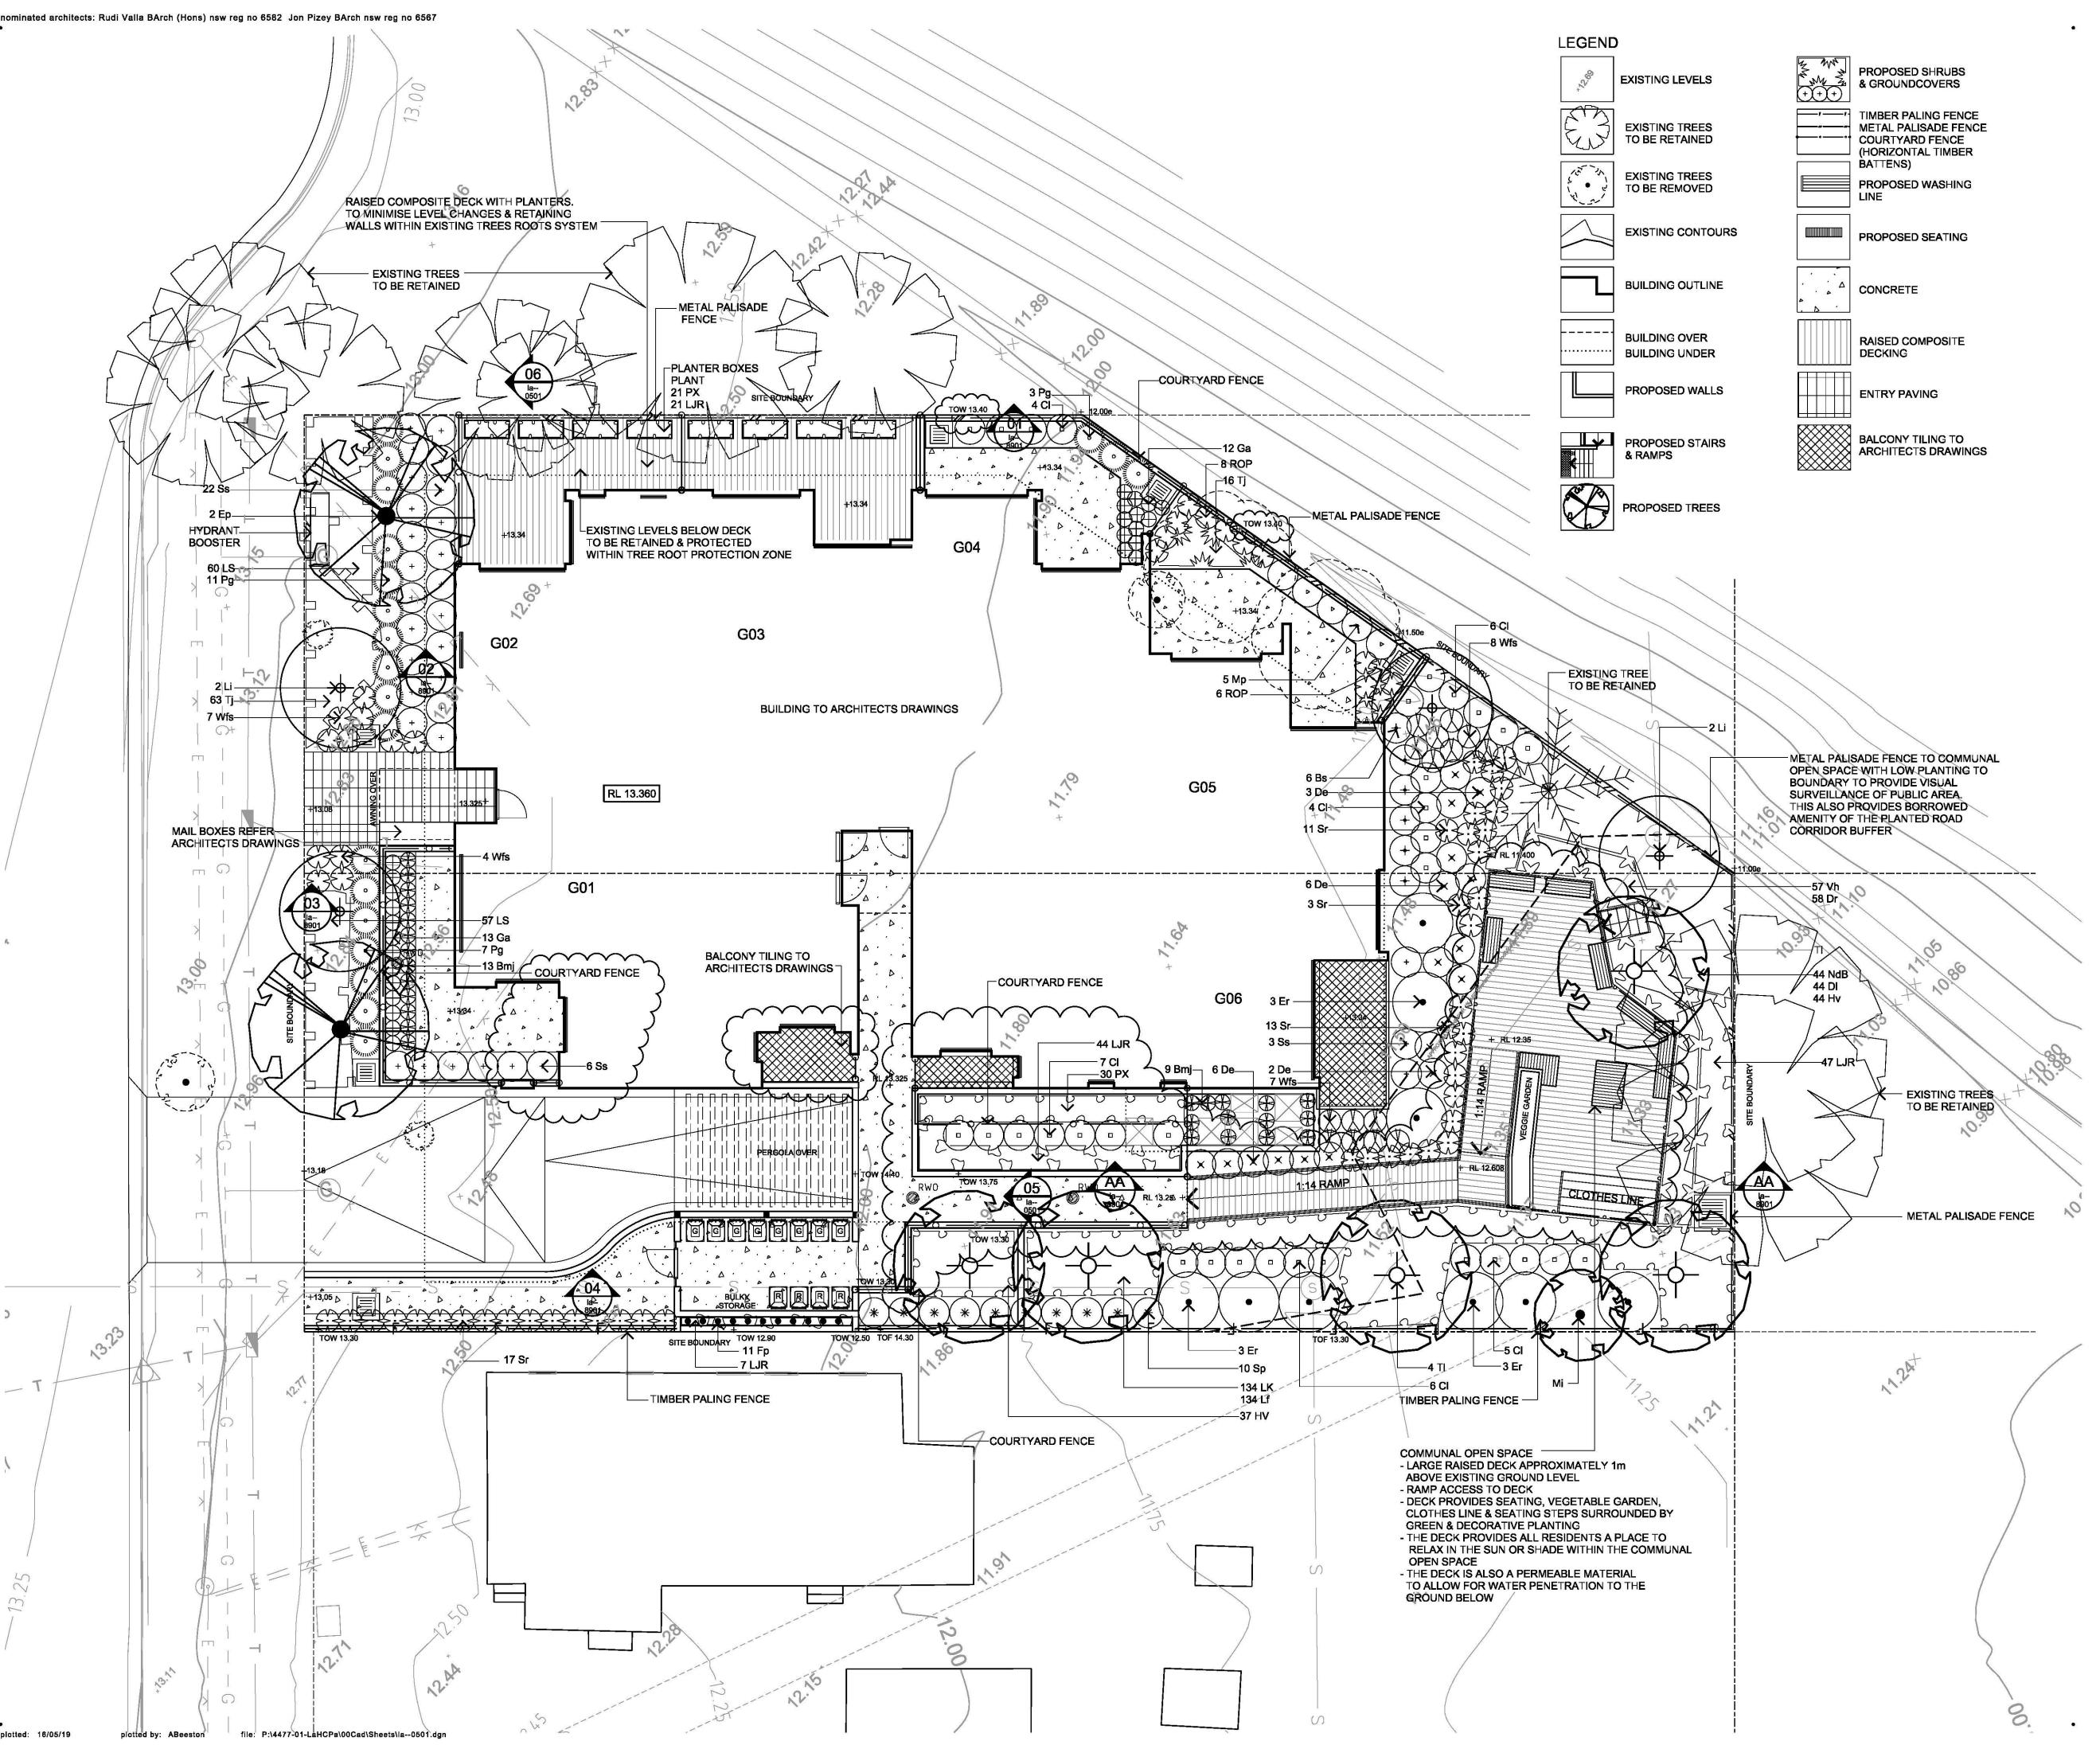
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landscape title sheet

| original | scale | drawn | project |
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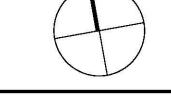
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| A04 | 14/09/18 | DA ISSUE | JB | JB | AB | AB |
| A05 | 30/04/19 | REVISED DA ISSUE | AB | AB | AB | AB |
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north point

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Family & Community Services
Land & Housing Corporation

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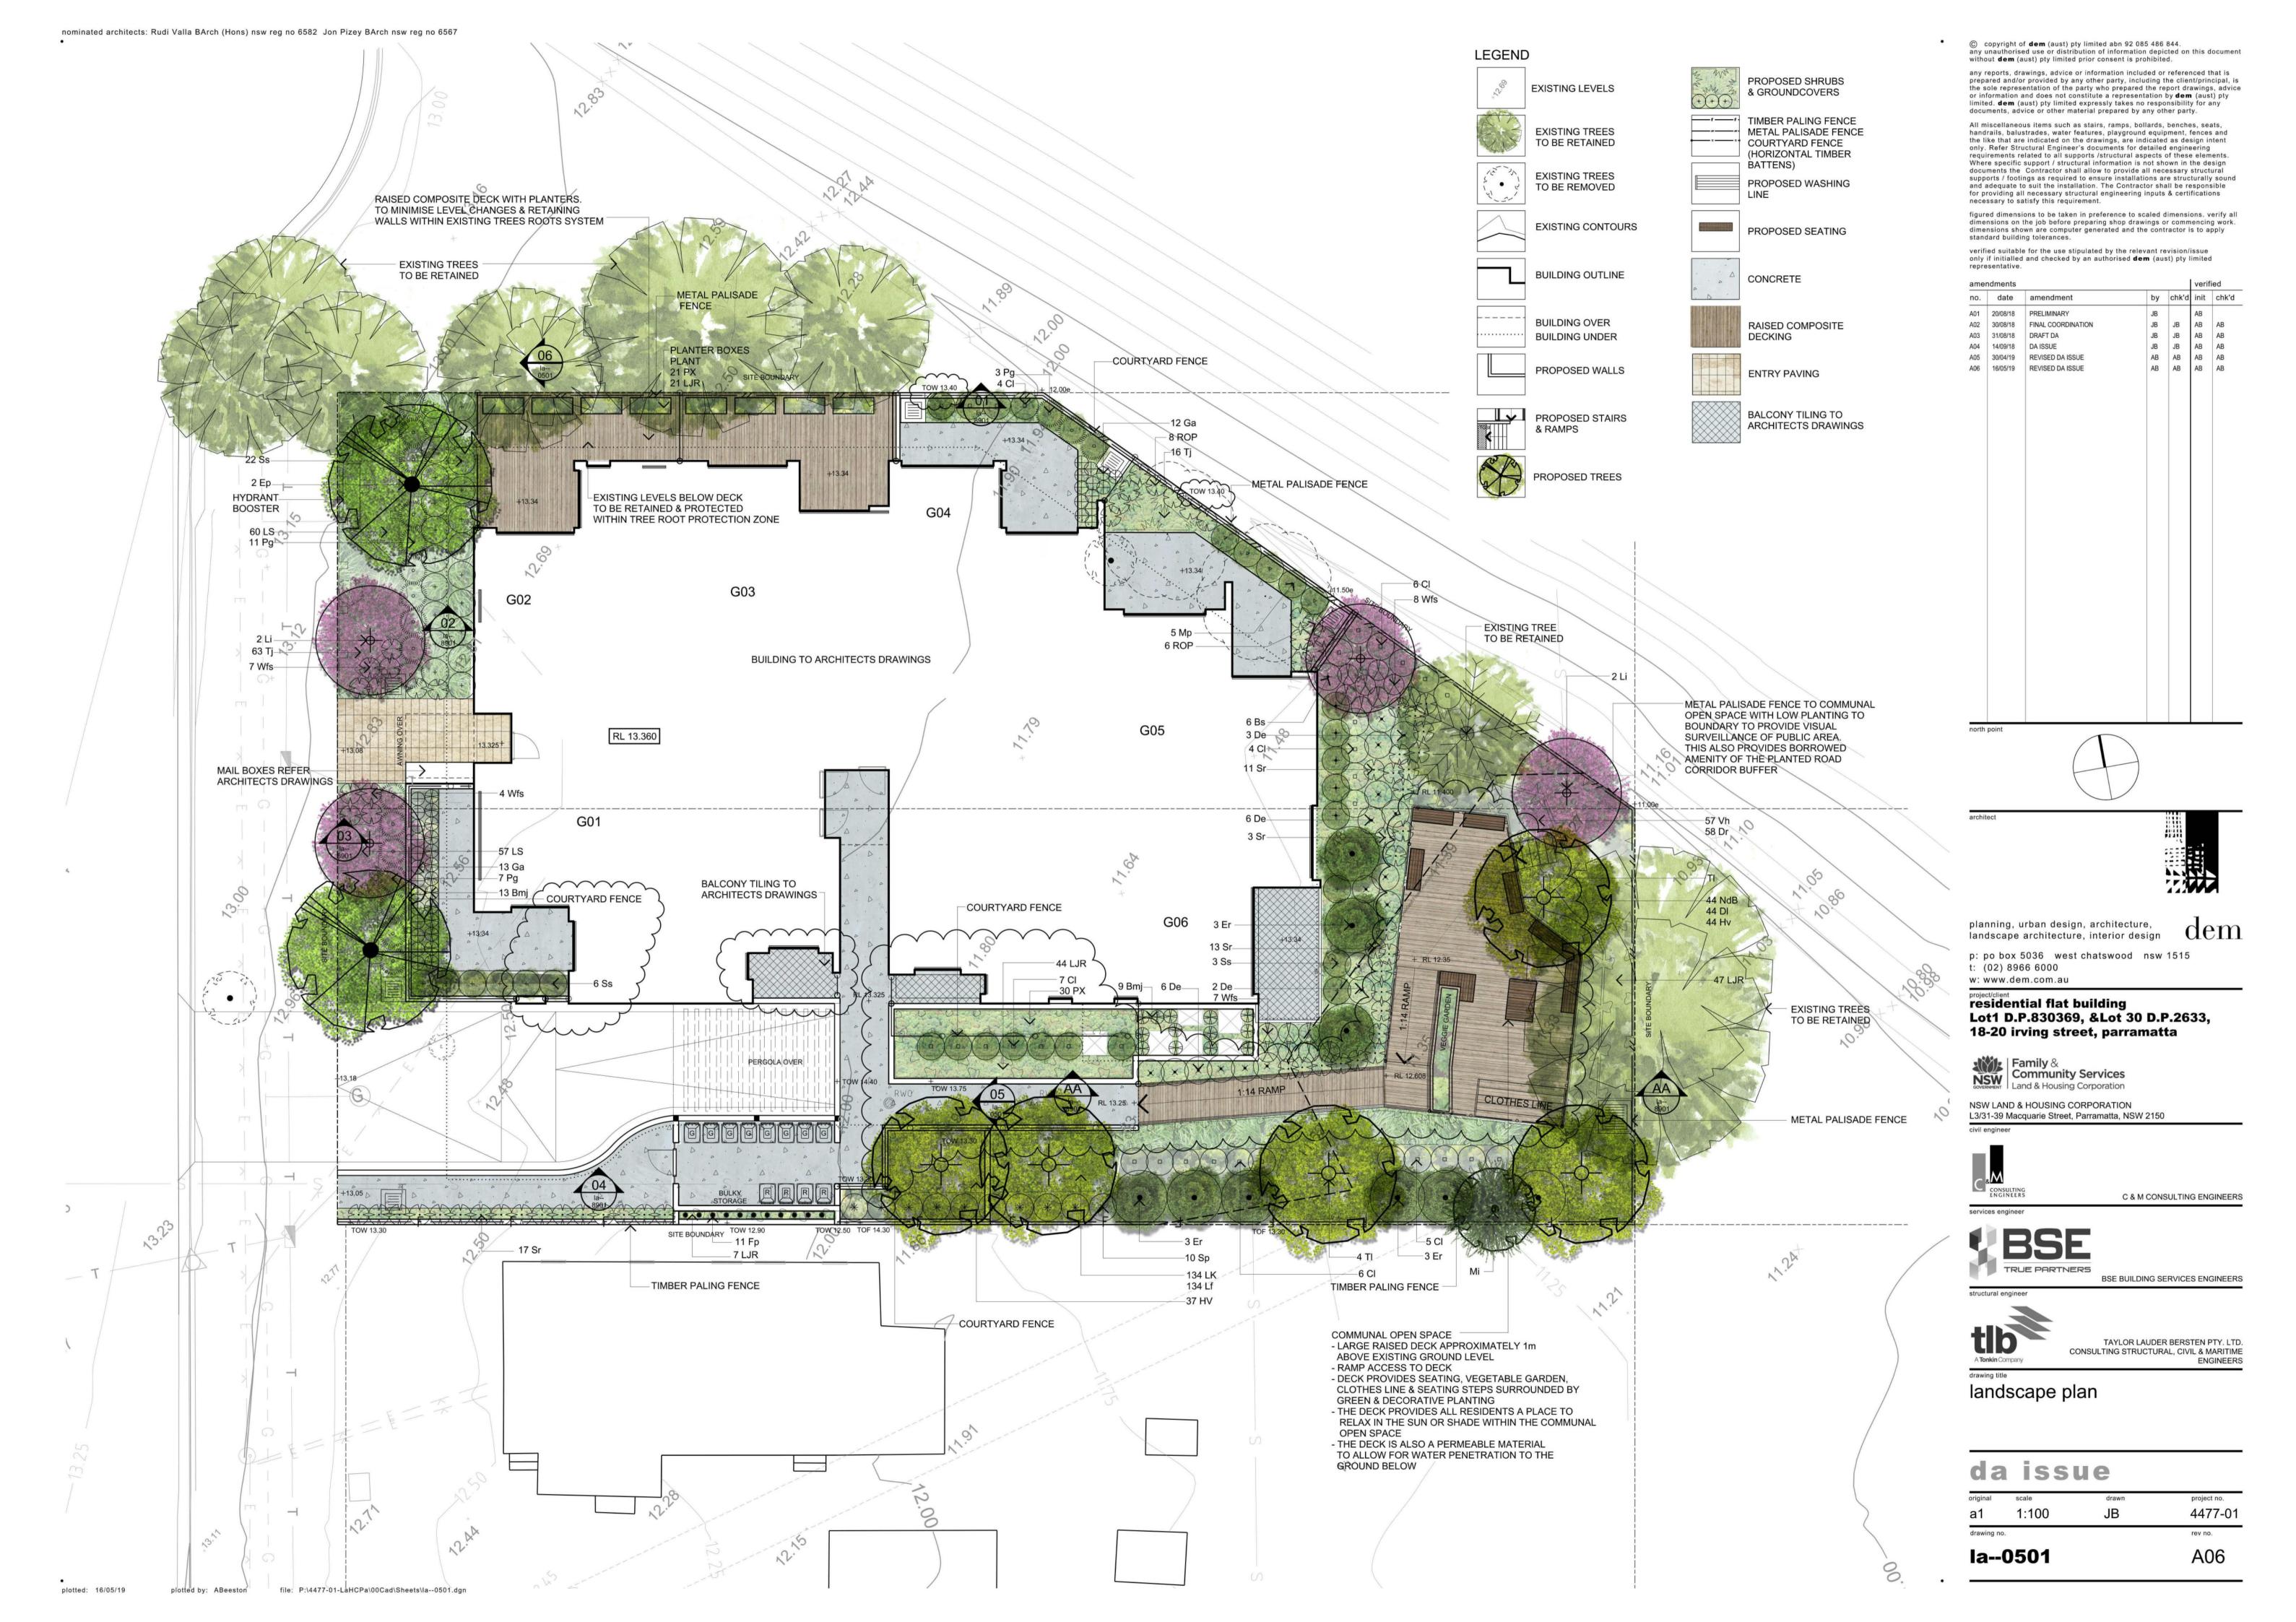



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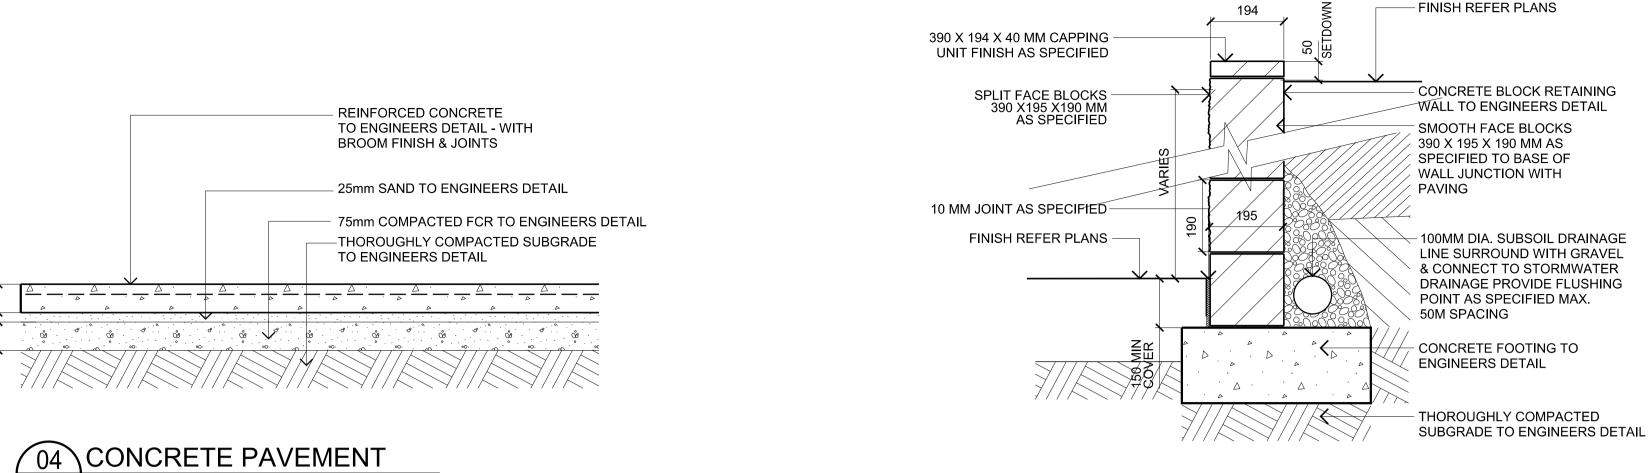
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da issue


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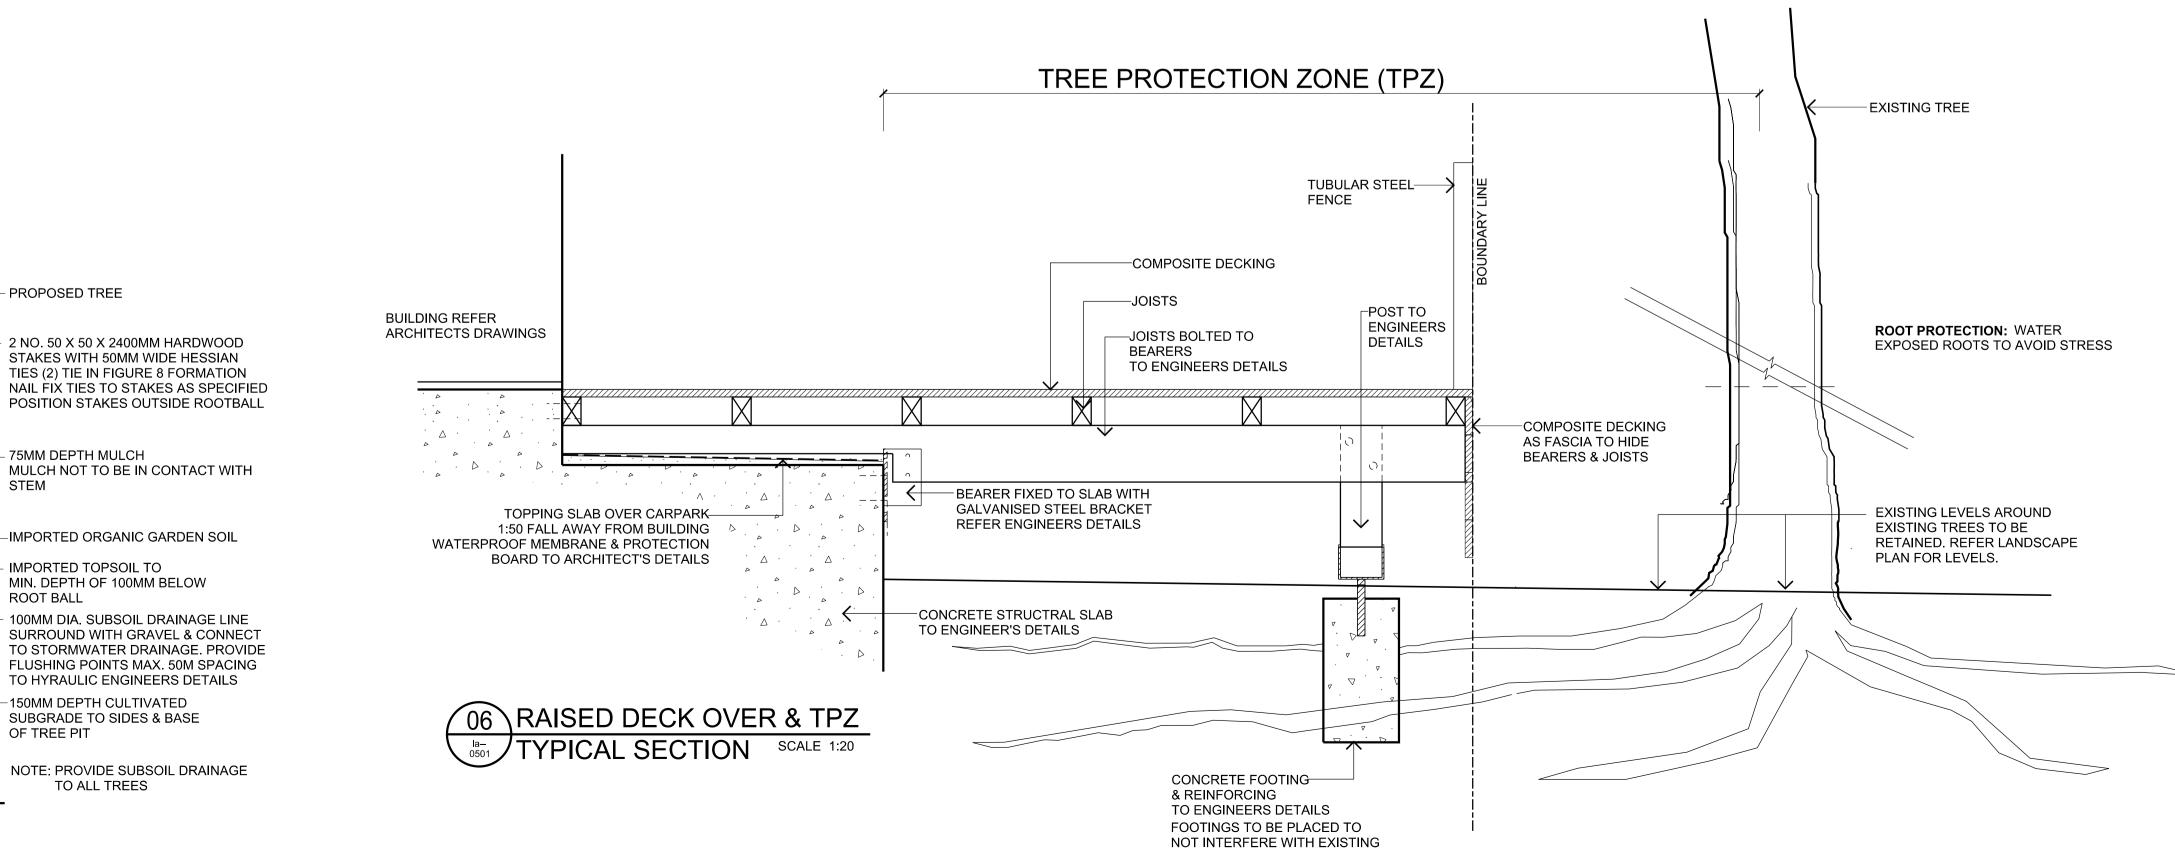






TYPICAL SECTION SCALE 1:10 05 CONCRETE BLOCK WALL TYPICAL SECTION SCALE 1:10

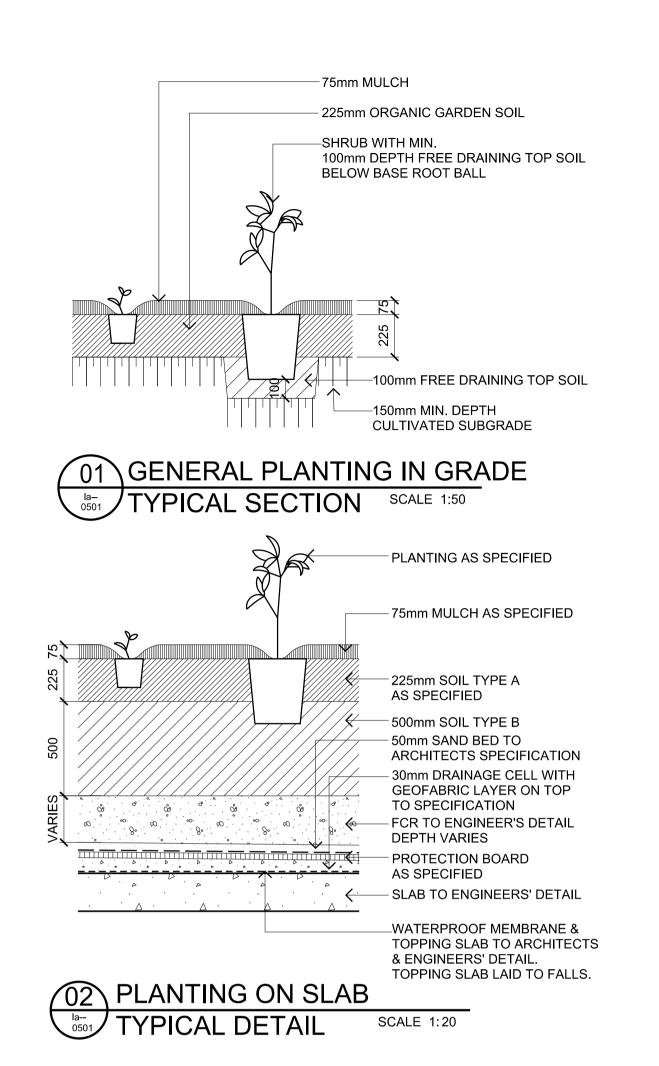

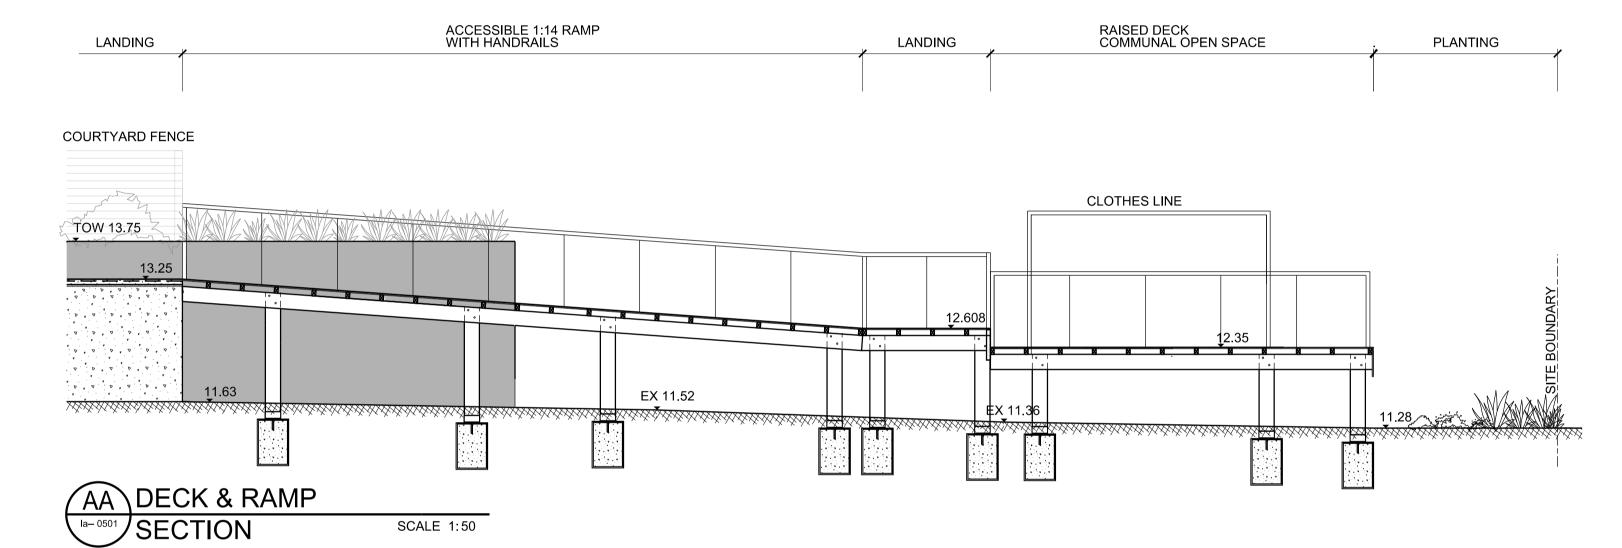

TREE ROOT ZONES

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landscape details

da issue

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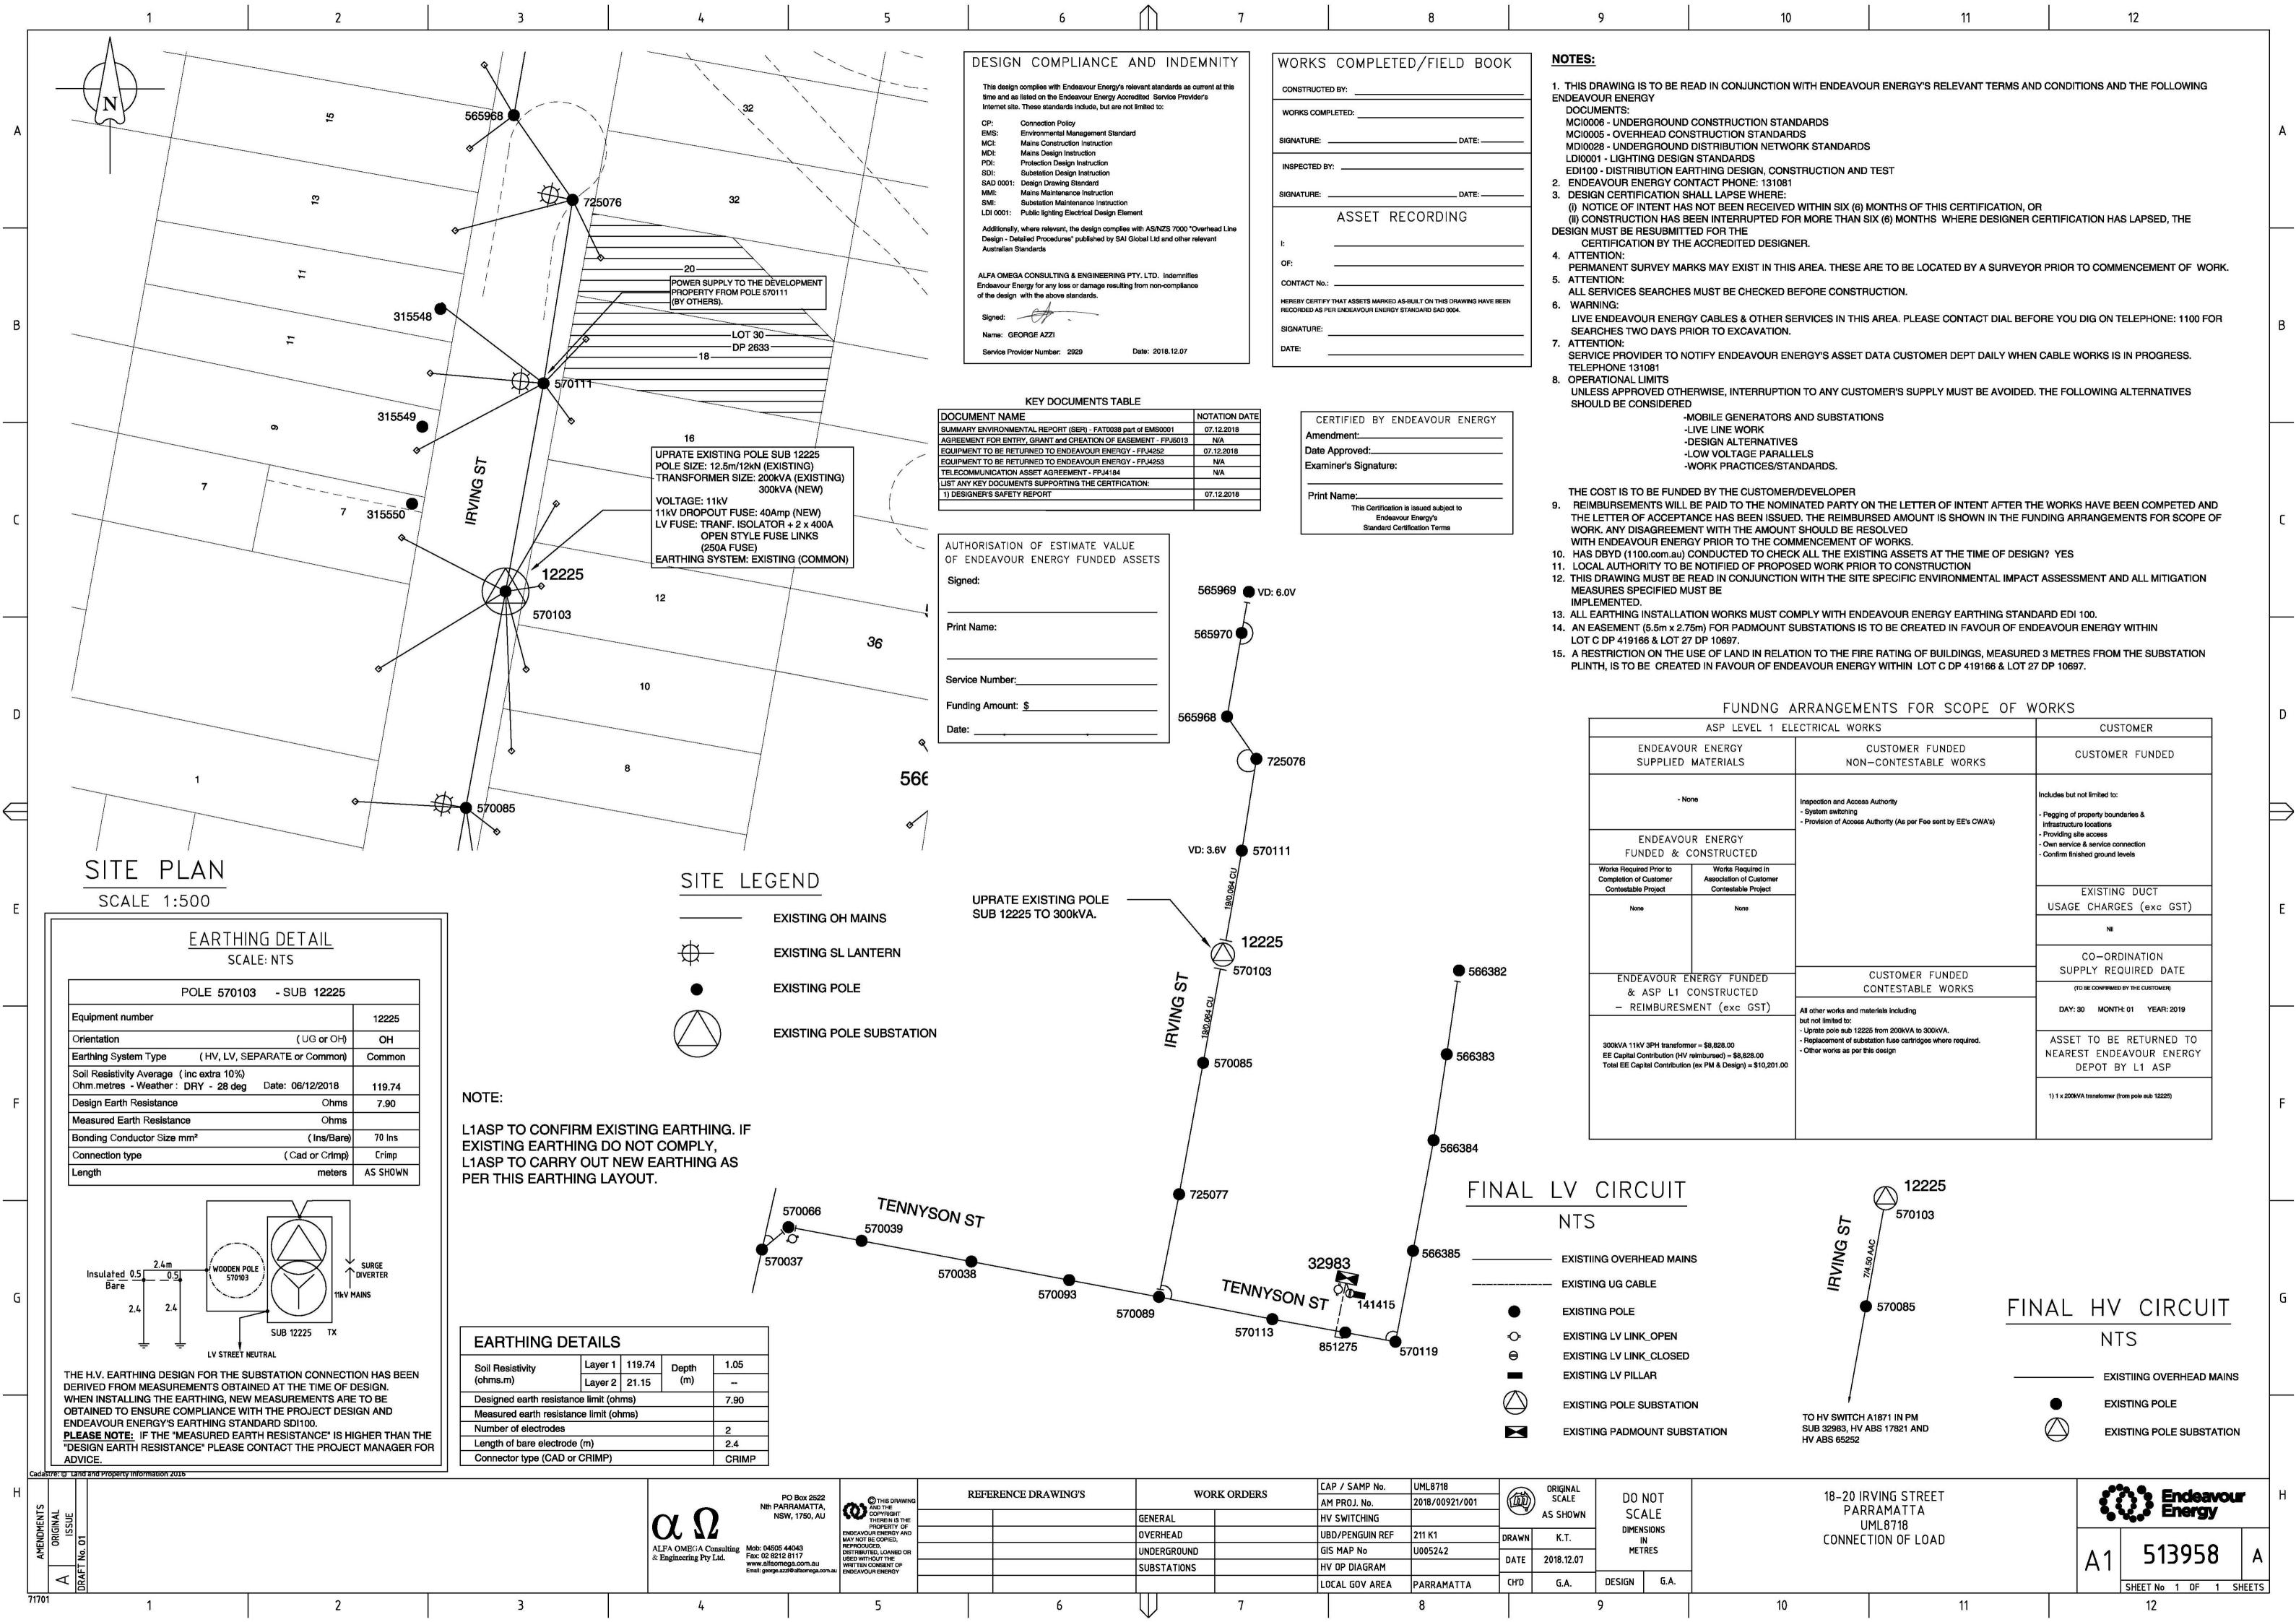
TREE PLANTING


SLOPE BASE FOR POSITIVE -

FALL TO SUBSOIL DRAINAGE

BALL

STEM



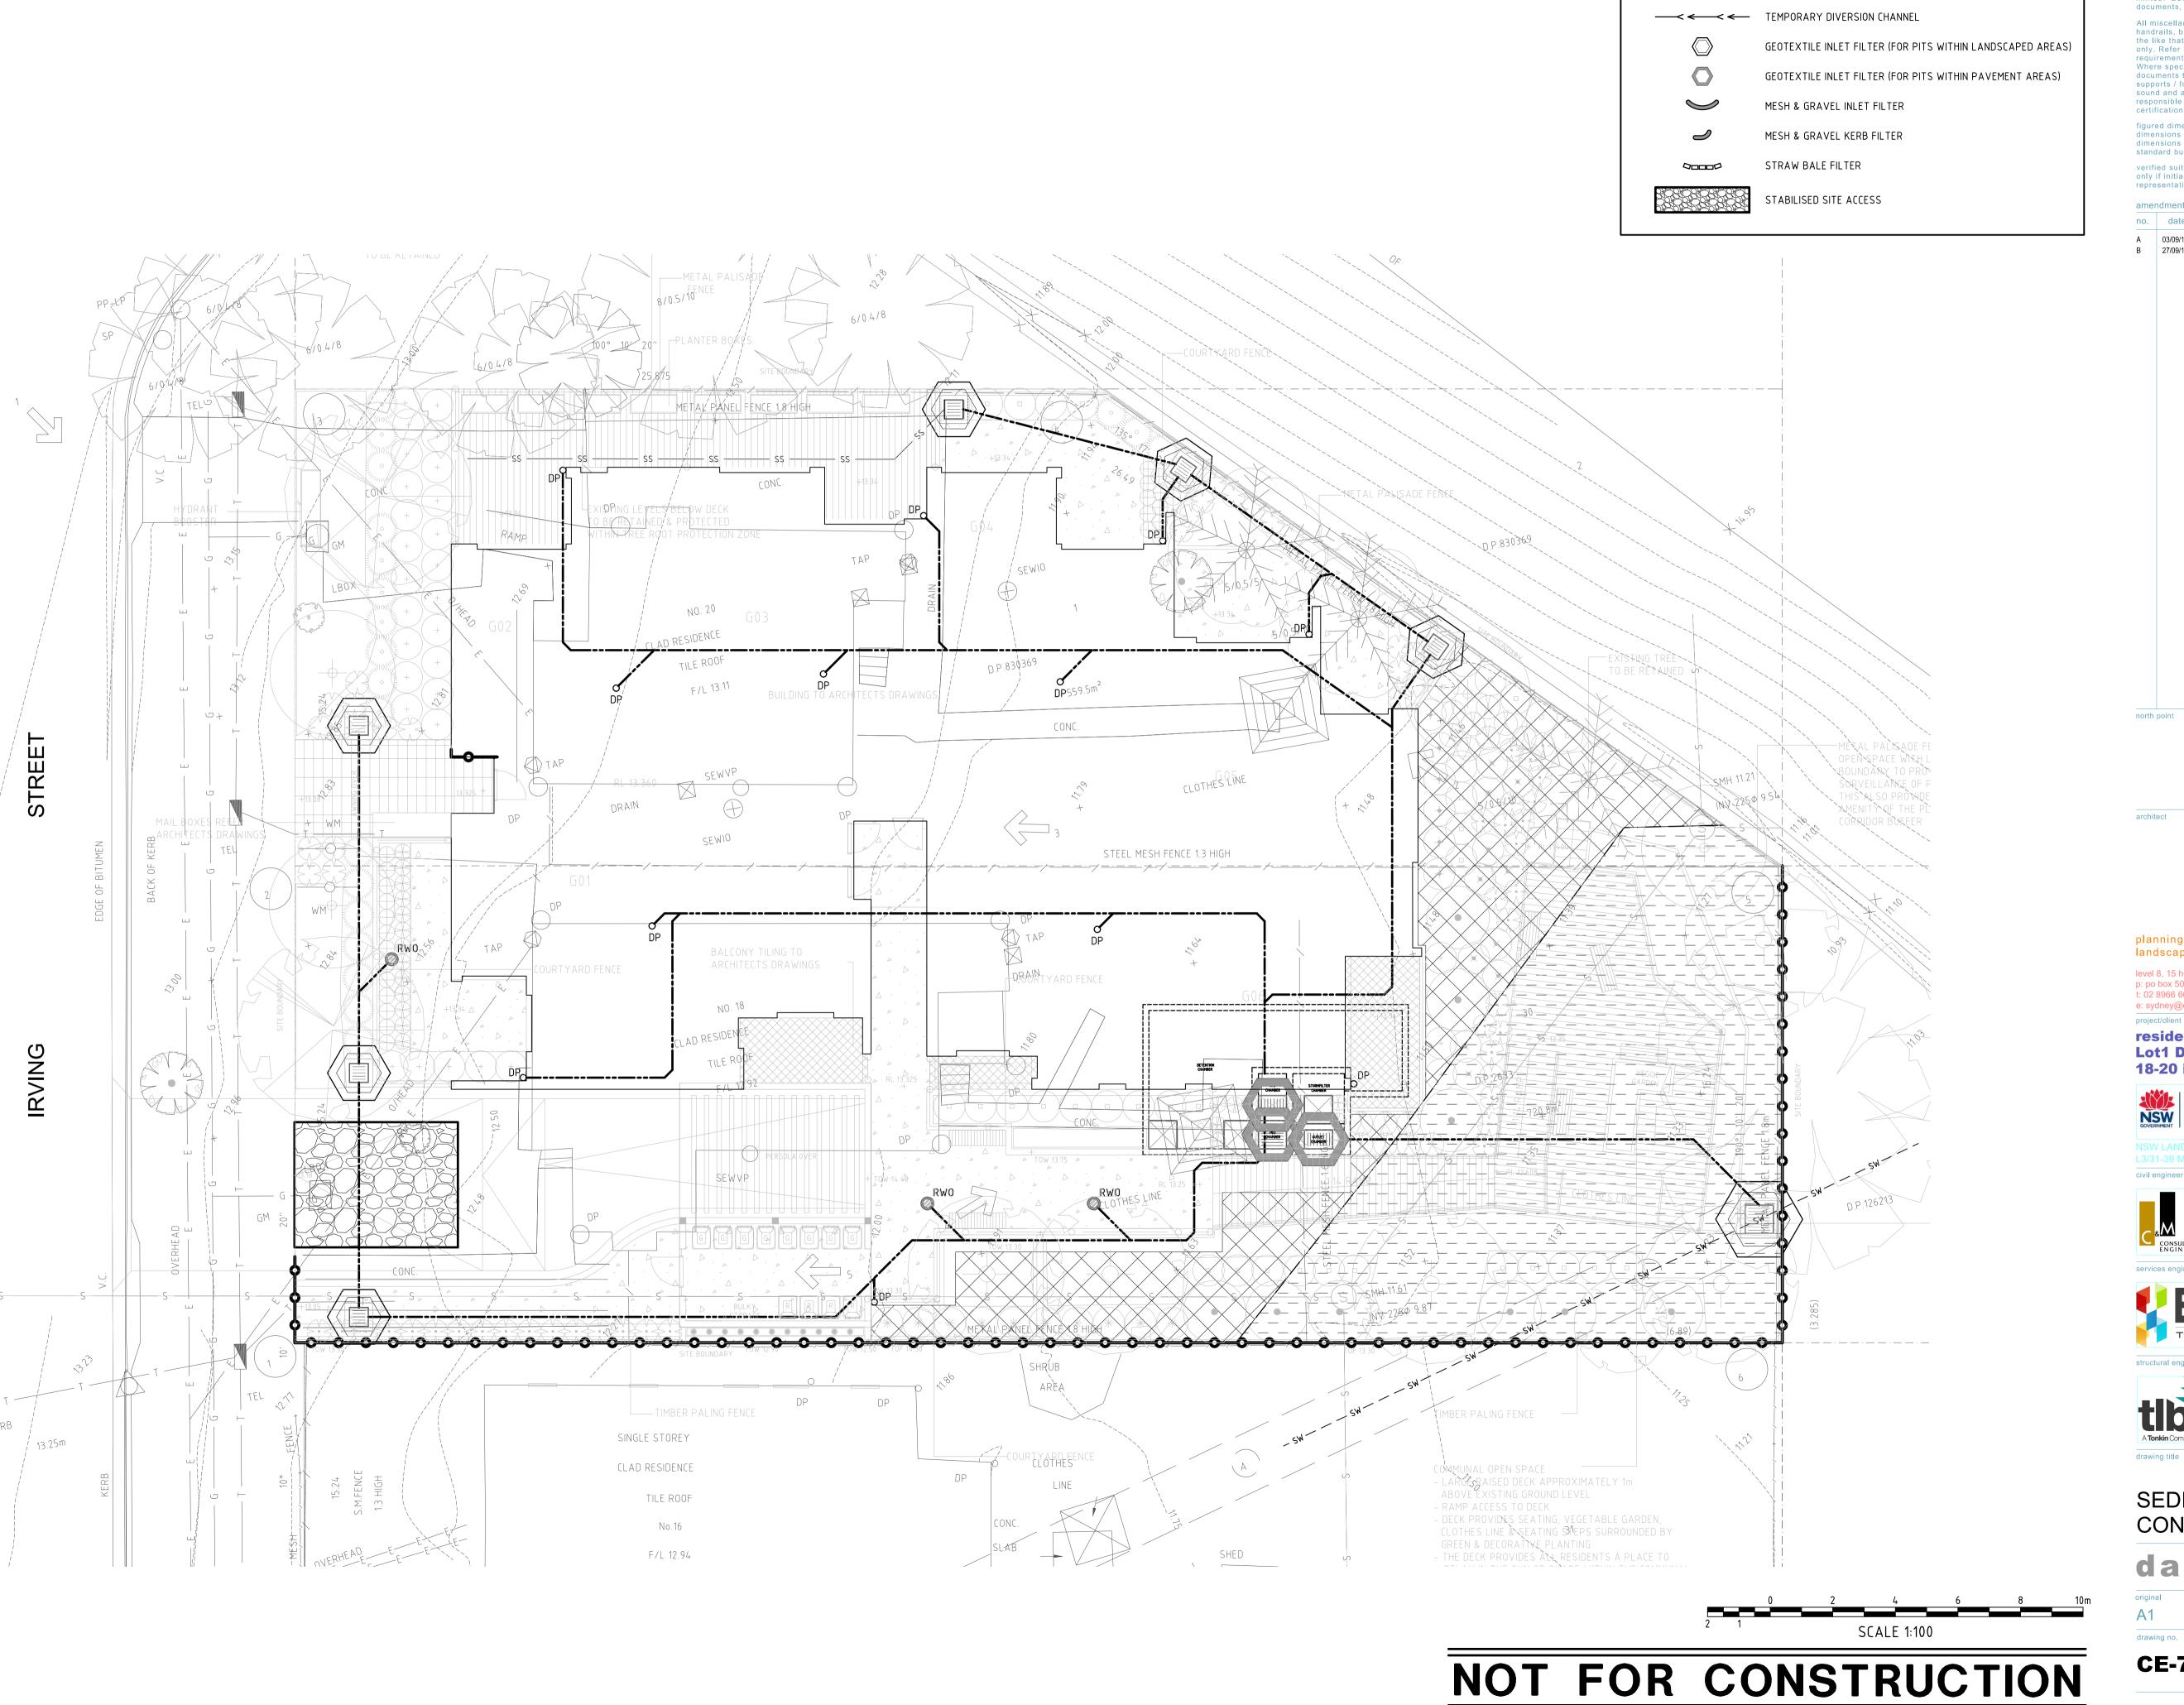

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landscape architecture, interior design level 8, 15 help street chatswood, nsw 2067 p: po box 5036 west chatswood nsw 1515 t: 02 8966 6000 f: 02 8966 6111 e: sydney@dem.com.au

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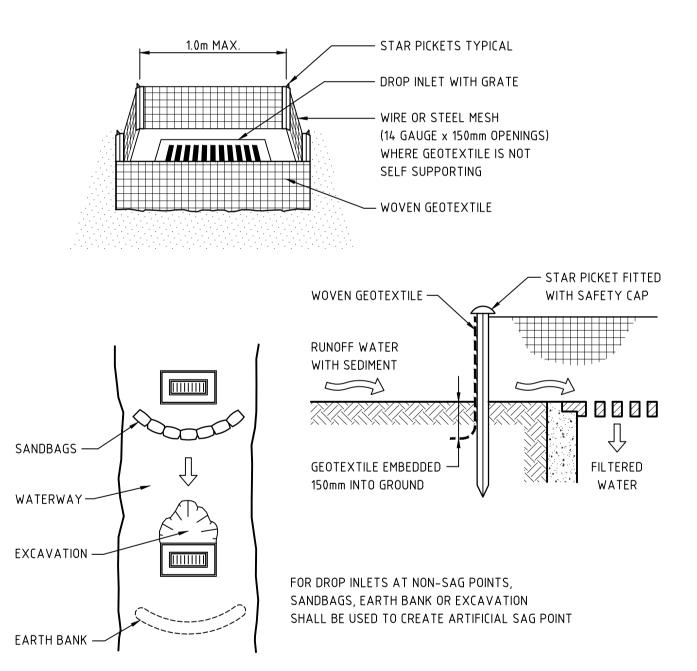


SEDIMENT & EROSION CONTROL PLAN

da issue

project no. A1 1:100 01959 A.M. drawing no. В

CE-701




CONSTRUCTION NOTES:

- FABRICATE A SEDIMENT BARRIER MADE FROM GEOTEXTILE OR STRAW BALES.
 IN WATERWAYS, ARTIFICIAL SAG POINTS CAN BE CREATED WITH SANDBAGS OR EARTH BANKS
- AS SHOWN IN THE DRAWING.
- 3. DO NOT COVER THE INLET WITH GEOTEXTILE UNLESS THE DESIGN IS ADEQUATE TO ALLOW FOR ALL WATERS TO BYPASS IT.

GEOTEXTILE INLET FILTER DETAIL

FOR PITS WITHIN LANDSCAPED AREAS


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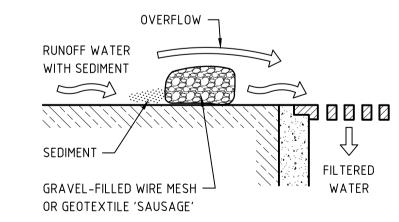


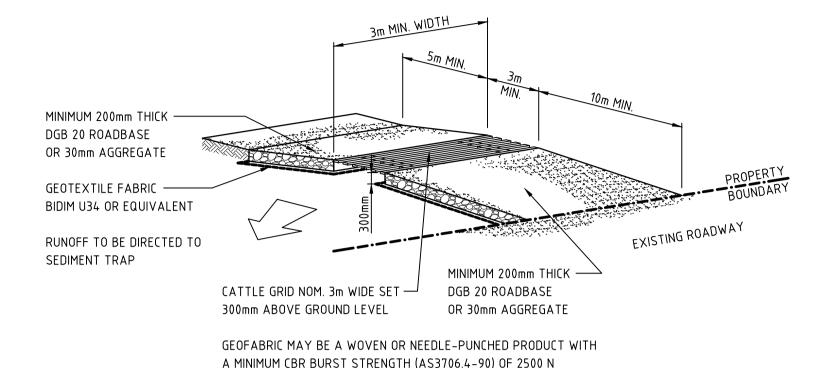CONSTRUCTION NOTES:

- 1. STRIP THE TOPSOIL, LEVEL THE SITE AND COMPACT THE SUBGRADE.
- 2. COVER THE AREA WITH NEEDLE-PUNCHED GEOTEXTILE.
- 3. CONSTRUCT A 200mm THICK PAD OVER THE GEOTEXTILE USING ROAD BASE OR 30mm AGGREGATE.
- ENSURE THE STRUCTURE IS AT LEAST 15m LONG OR TO BUILDING ALIGNMENT AND AT LEAST 3m WIDE.
 WHERE A SEDIMENT FENCE JOINS ONTO THE STABILISED ACCESS, CONSTRUCT A HUMP IN THE STABILISED ACCESS TO DIVERT WATER TO THE SEDIMENT FENCE.

STABILISED SITE ACCESS WITH SHAKER GRID DETAIL



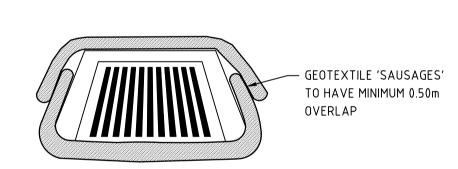

CONSTRUCTION NOTES:

- FABRICATE A SEDIMENT BARRIER MADE FROM GEOTEXTILE OR STRAW BALES.
- 2. DO NOT COVER THE INLET WITH GEOTEXTILE UNLESS THE DESIGN IS ADEQUATE TO ALLOW FOR ALL WATERS TO BYPASS IT.

GEOTEXTILE INLET FILTER DETAIL

FOR PITS WITHIN PAVEMENT AREAS

NOT TO SCALE

SELF - SUPPORTING
GEOTEXTILE

150mm x 100mm TRENCH
WITH COMPACTED BACKFILL
TRENCH TO BE HAND DUG

SECTION OF FLOW

1.5m STAR PICKETS
AT MAX 2.5m CENTRES

20m MAX

(UNLESS STATED OTHERWISE)

STAR PICKETS AT MAXIMUM
2.5m SPACINGS
PLAN

CONSTRUCTION NOTES:

- 1. CONSTRUCT SEDIMENT FENCES AS CLOSE AS POSSIBLE TO BEING PARALLEL TO THE CONTOURS OF THE SITE, BUT WITH SMALL RETURNS AS SHOWN IN THE DRAWING TO LIMIT THE CATCHMENT AREA OF ANY ONE SECTION. THE CATCHMENT AREA SHOULD BE SMALL ENOUGH TO LIMIT WATER FLOW IF CONCENTRATED AT ONE POINT TO 50 LITRES PER SECOND IN
- THE DESIGN STORM EVENT, USUALLY THE 10-YEAR EVENT.

 2. CUT A 150mm DEEP TRENCH ALONG THE UPSLOPE LINE OF THE FENCE FOR THE BOTTOM OF THE FABRIC TO BE
- ENTRENCHED.

 3. DRIVE 1.5 METRE LONG STAR PICKETS INTO THE GROUND AT 2.5 METRE INTERVALS (MAX) AT THE DOWNSLOPE EDGE OF
- THE TRENCH. ENSURE ANY STAR PICKETS ARE FITTED WITH SAFETY CAPS.

 4. FIX SELF SUPPORTING GEOTEXTILE TO THE UPSLOPE SIDE OF THE POSTS ENSURING IT GOES TO THE BASE OF THE TRENCH. FIX THE GEOTEXTILE WITH WIRE TIES OR AS RECOMMENDED BY THE MANUFACTURER. ONLY USE GEOTEXTILE
- SPECIFICALLY PRODUCED FOR SEDIMENT FENCING. THE USE OF SHADE CLOTH FOR THIS PURPOSE IS NOT SATISFACTORY.

 5. JOIN SECTIONS OF FABRIC AT A SUPPORT POST WITH A 150-mm OVERLAP.

 6. BACKFILL THE TRENCH OVER THE BASE OF THE FABRIC AND COMPACT IT THOROUGHLY OVER THE GEOTEXTILE.

SEDIMENT FENCE DETAIL

NOT TO SCALE

NOT FOR CONSTRUCTION

no. date amendment by chk'd init chk'd A 03/09/18 PRELIMINARY ISSUE A.M. 03/09 E.S. 03/09 B 27/09/18 DA ISSUE A.M. 27/09 E.S. 27/09

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certifications necessary to satisfy this requirement.

standard building tolerances.

amendments

AT MAX. 2.5m CENTRES

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north point

residential flat building
Lot1 D.P.830369, &Lot 30 D.P.2633,
18-20 irving street, parramatta



NEW LAND & HOUSING CORPORATION





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drawing title

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SEDIMENT & EROSION CONTROL DETAILS



original scale drawn project no.

A1 NA A.M. 01959

drawing no. rev no.

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